

PROPOSED DRIVEWAY CROSS-OVER PROPOSED ROAD KERB PROPOSED ROAD CONTROL LINE

PROPOSED TURF / LANDSCAPING PROPOSED NEW BUILDING (BY OTHERS) PROPOSED CONCRETE PATHWAY PROPOSED PAVED PATHWAY

SITE TYPE SUMMARY					
SITE TYPE	SIZE	NUMBER OF (STAGE 1)	NUMBER OF (STAGE 2)	NUMBER OF (TOTAL)	
CARAVAN SITE (CV)	13m x 9m	29	16	45	
CABIN SITE (CB)	13m x 9m	0	0	0	
CAMP SITE (CS)	6.7m (MIN) x 9m	5	12	17	
TOTAL	-	34	28	62	

REFER ARCHITECTURAL DRAWINGS FOR FINAL BUILDING FOOTPRINTS, FLOOR PLANS AND ASSOCIATED PEDESTRIAN FOOTPATHS TO PROPOSED DEVELOPMENT.

operated rayishon CS CS 0160//224 APPROVED DATE DETAILS OF AMENDMENTS

APPROVED rector: CAMERON LANDRETH (RPEQ 19358)

Shelley GONBULTING ENGINEERS		Barlow Shelley	
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SURVEYSURVEYORS@WORK

HORIZ GDA 2020 (MGA ZONE 56 HEIGHT DATUM

SURVEY PSM 152238 RL 3.400 DESIGN HAS BEEN REVIEWED AGAINST PROJECT SCOPE FOR COMPLIANCE WITH RELEVANT DESIGN STANDARDS AND SPECIFICATIONS AND IS DEEMED SUITABLE FOR CONSTRUCTION PURPOSES LOCATION OF PSM ESPLANADE


RELEASED FOR CONSTRUCTION





FRASER COAST REGIONAL COUNCIL

TORQUAY CARAVAN PARK - STAGE 1 AND 2 REDEVELOPMENT OF FCRC CARAVAN PARKS OVERALL LAYOUT PLAN


00 OF 00 DRGS

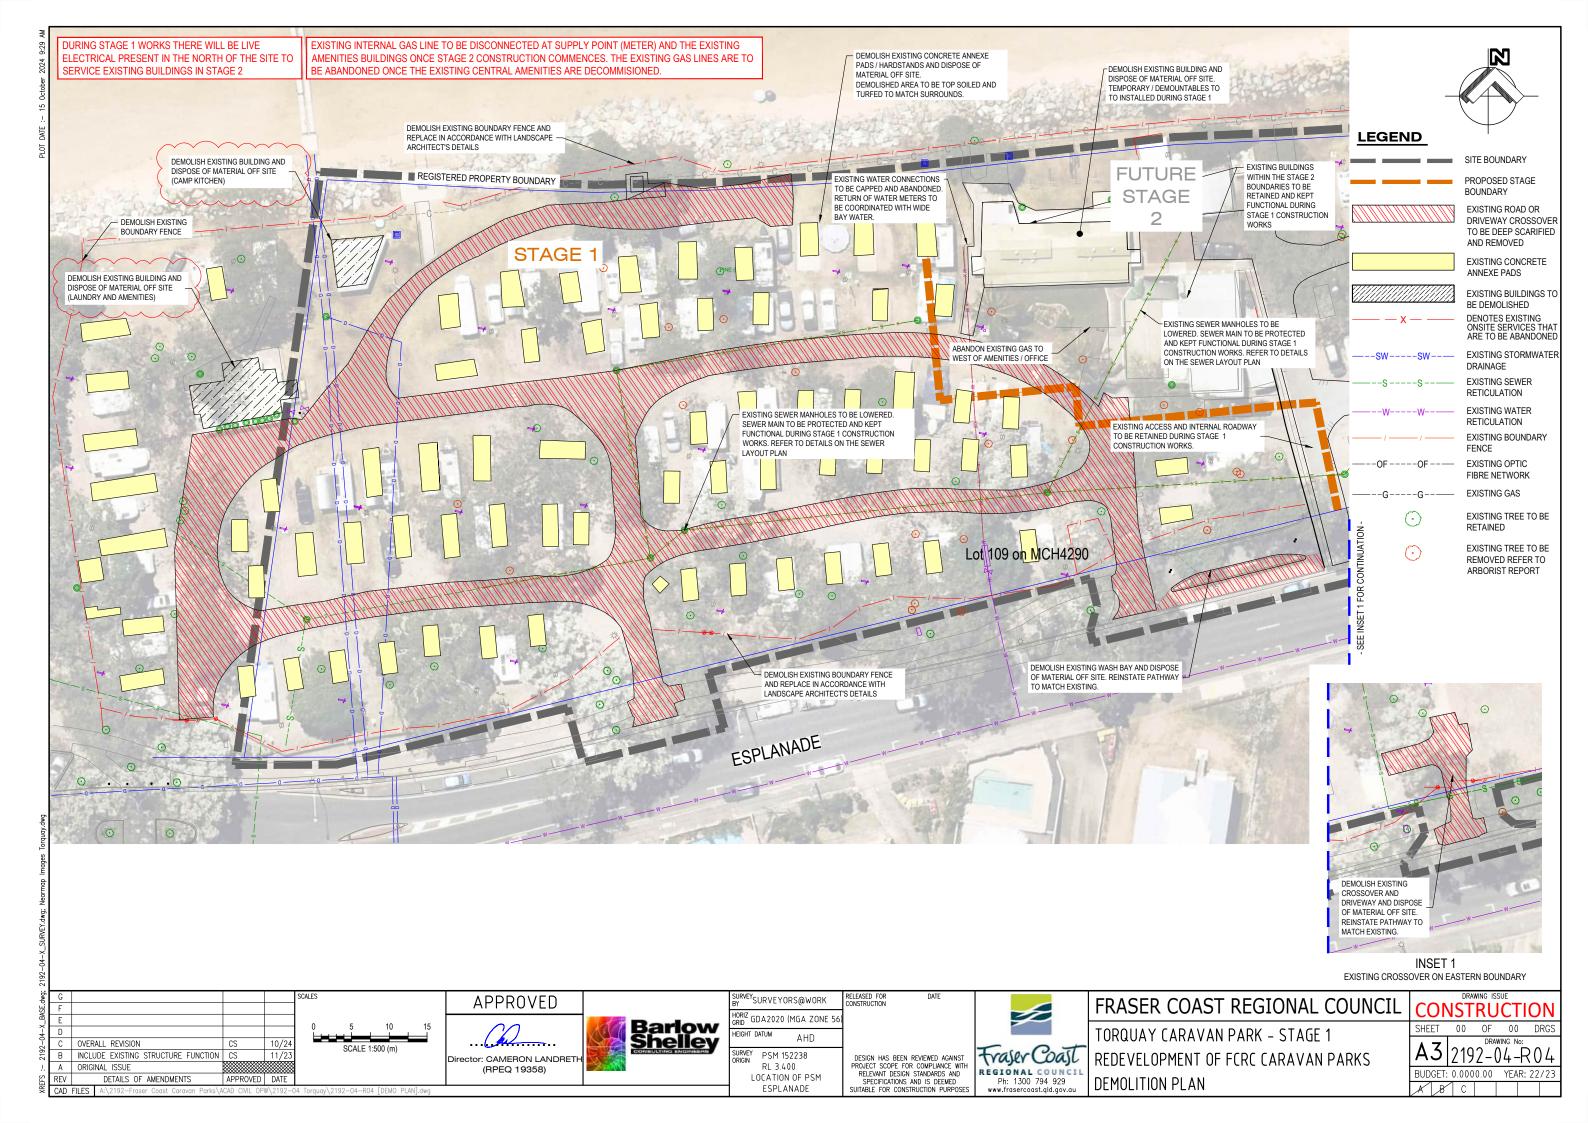

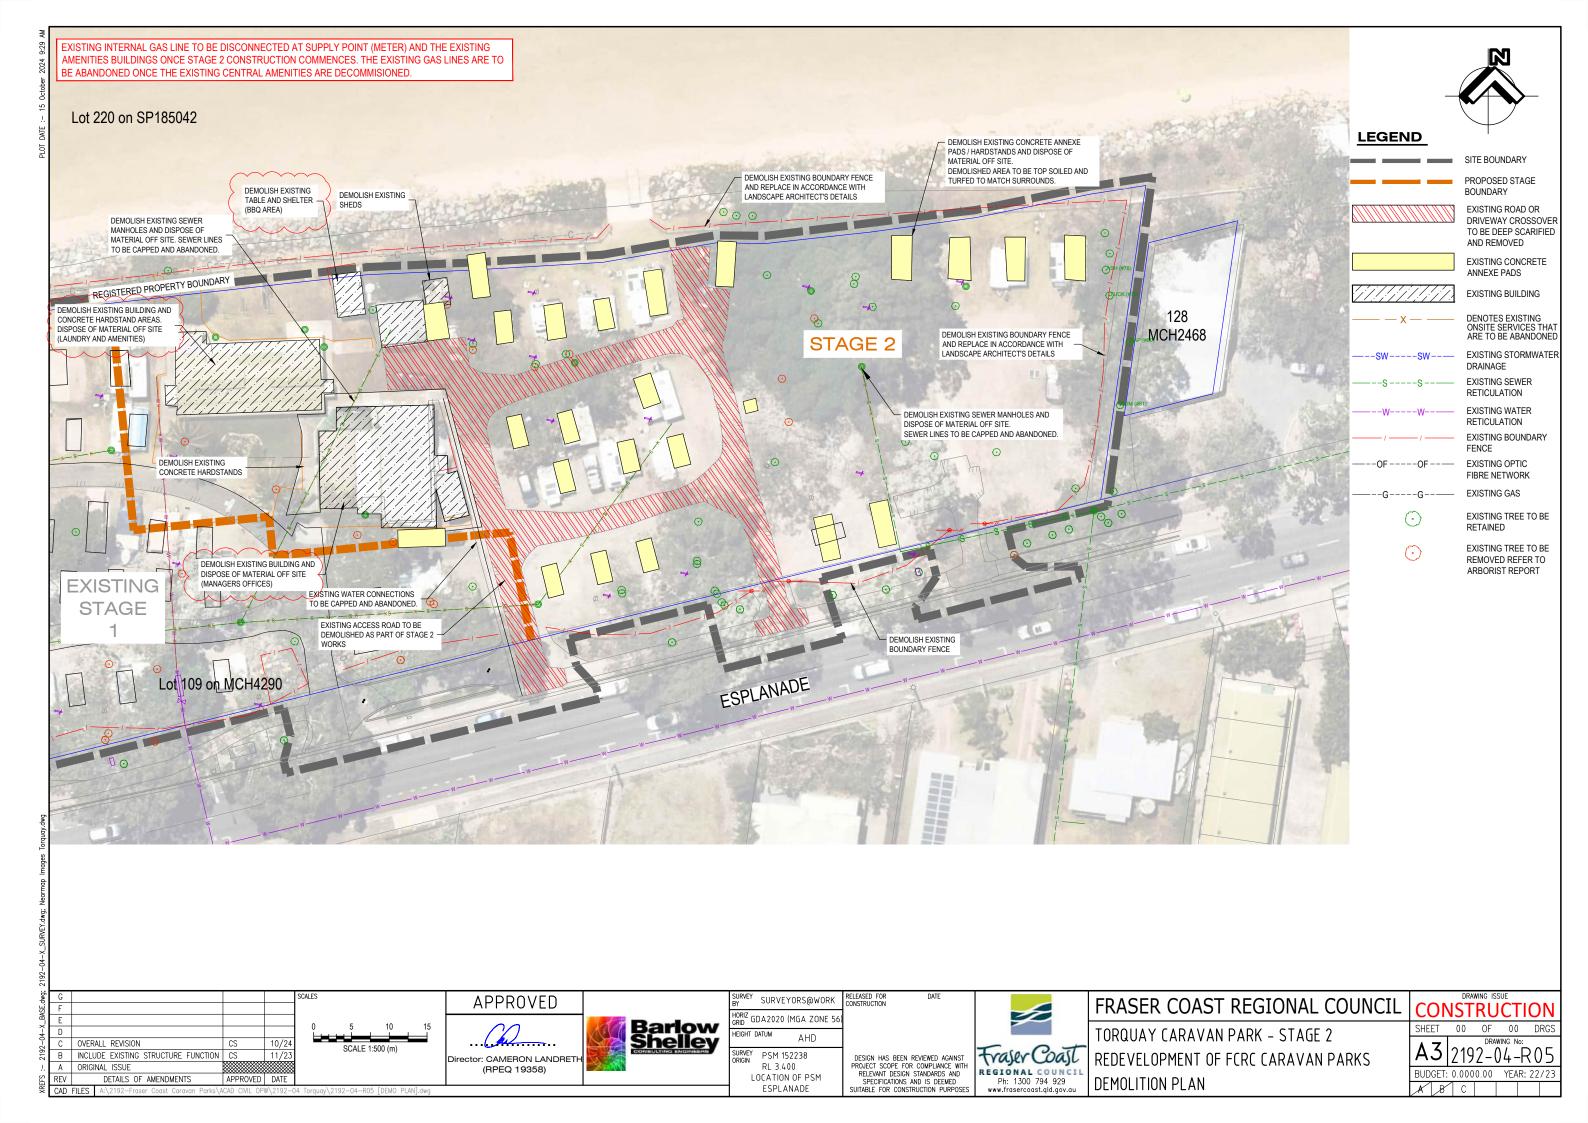


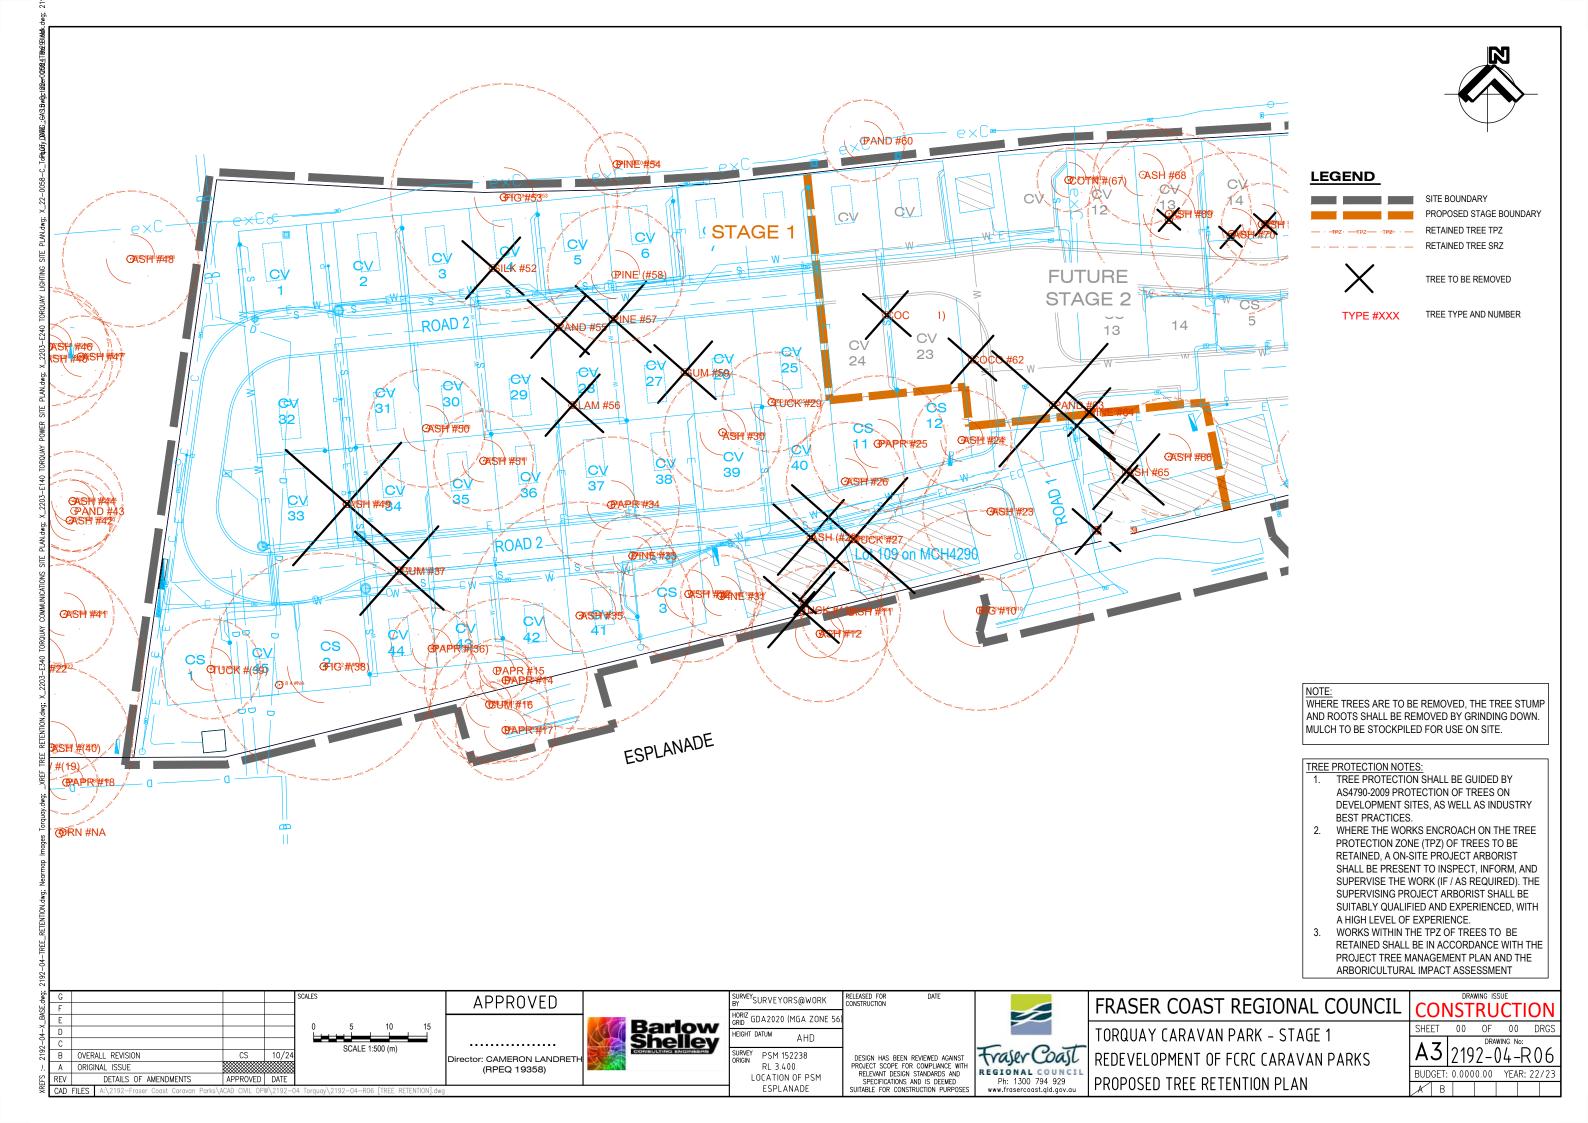

Lot 220 on SP185042

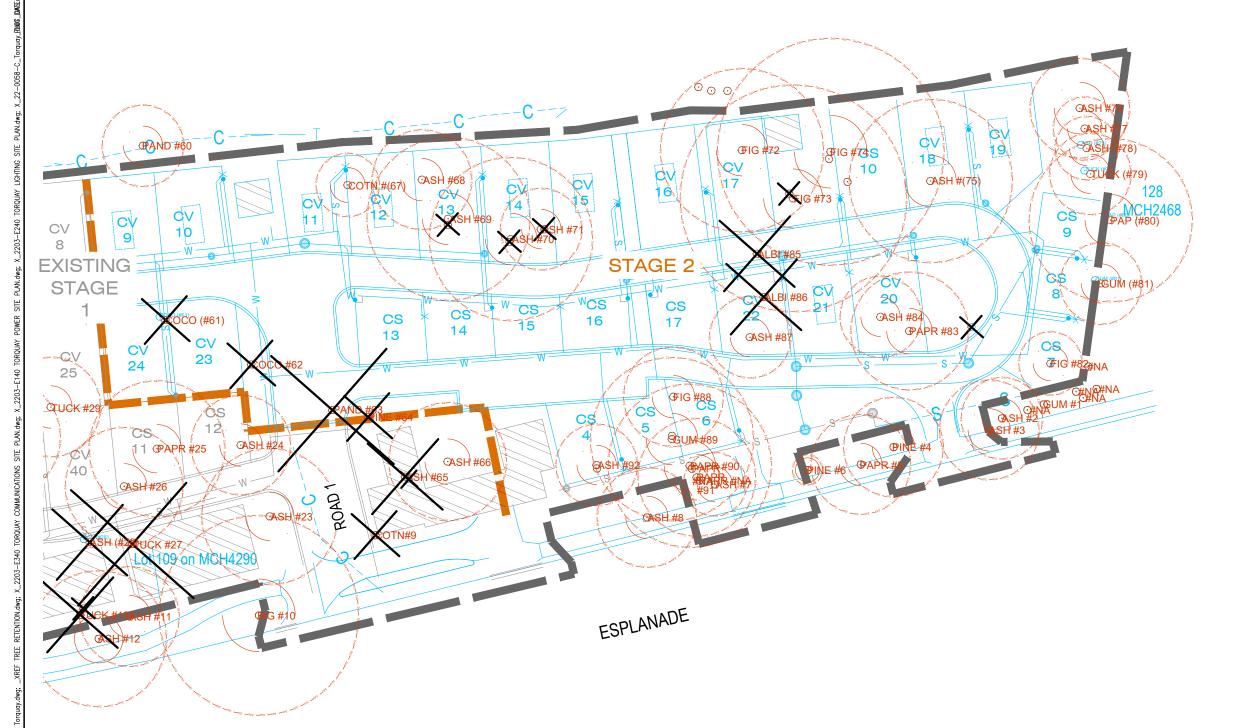

LEGEND

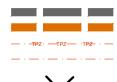

SITE BOUNDARY
PROPOSED STAGE BOUNDARY
RETAINED TREE TPZ

X

TREE TO BE REMOVED

RETAINED TREE SRZ

TYPE #XXX

TREE TYPE AND NUMBER

NOTE

WHERE TREES ARE TO BE REMOVED, THE TREE STUMP AND ROOTS SHALL BE REMOVED BY GRINDING DOWN. MULCH TO BE STOCKPILED FOR USE ON SITE.

TREE PROTECTION NOTES:

- TREE PROTECTION SHALL BE GUIDED BY
 AS4790-2009 PROTECTION OF TREES ON
 DEVELOPMENT SITES, AS WELL AS INDUSTRY
 BEST PRACTICES.
- 2. WHERE THE WORKS ENCROACH ON THE TREE PROTECTION ZONE (TPZ) OF TREES TO BE RETAINED, A ON-SITE PROJECT ARBORIST SHALL BE PRESENT TO INSPECT, INFORM, AND SUPERVISE THE WORK (IF / AS REQUIRED). THE SUPERVISING PROJECT ARBORIST SHALL BE SUITABLY QUALIFIED AND EXPERIENCED, WITH A HIGH LEVEL OF EXPERIENCE.
- 3. WORKS WITHIN THE TPZ OF TREES TO BE RETAINED SHALL BE IN ACCORDANCE WITH THE PROJECT TREE MANAGEMENT PLAN AND THE ARBORICULTURAL IMPACT ASSESSMENT

F E E C C C B OVERALL REVISION A ORIGINAL ISSUE REV DETAILS OF AMENDMENTS

0 5 10 15 SCALE 1:500 (m)

APPROVED DATE

APPROVED

rector: CAMERON LANDRETH (RPEQ 19358)



SURVEYORS@WORK RELEASED FOR CONSTRUCTION HORIZ GDA2020 (MGA ZONE 56)

GHT DATUM AHD

RVEY PSM 152238
RL 3.400
LOCATION OF PSM

ESPLANADE

DESIGN HAS BEEN REVIEWED AGAINST PROJECT SCOPE FOR COMPLIANCE WITH RELEVANT DESIGN STANDARDS AND SPECIFICATIONS AND IS DEEMED SUITABLE FOR CONSTRUCTION PURPOSES



FRASER COAST REGIONAL COUNCIL


TORQUAY CARAVAN PARK - STAGE 2 REDEVELOPMENT OF FCRC CARAVAN PARKS PROPOSED TREE RETENTION PLAN


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	CONSTRUCTIO

SHEET 00 OF 00 DRGS


A3 2192-04-R07

BUDGET: 0.0000.00 YEAR: 22/23

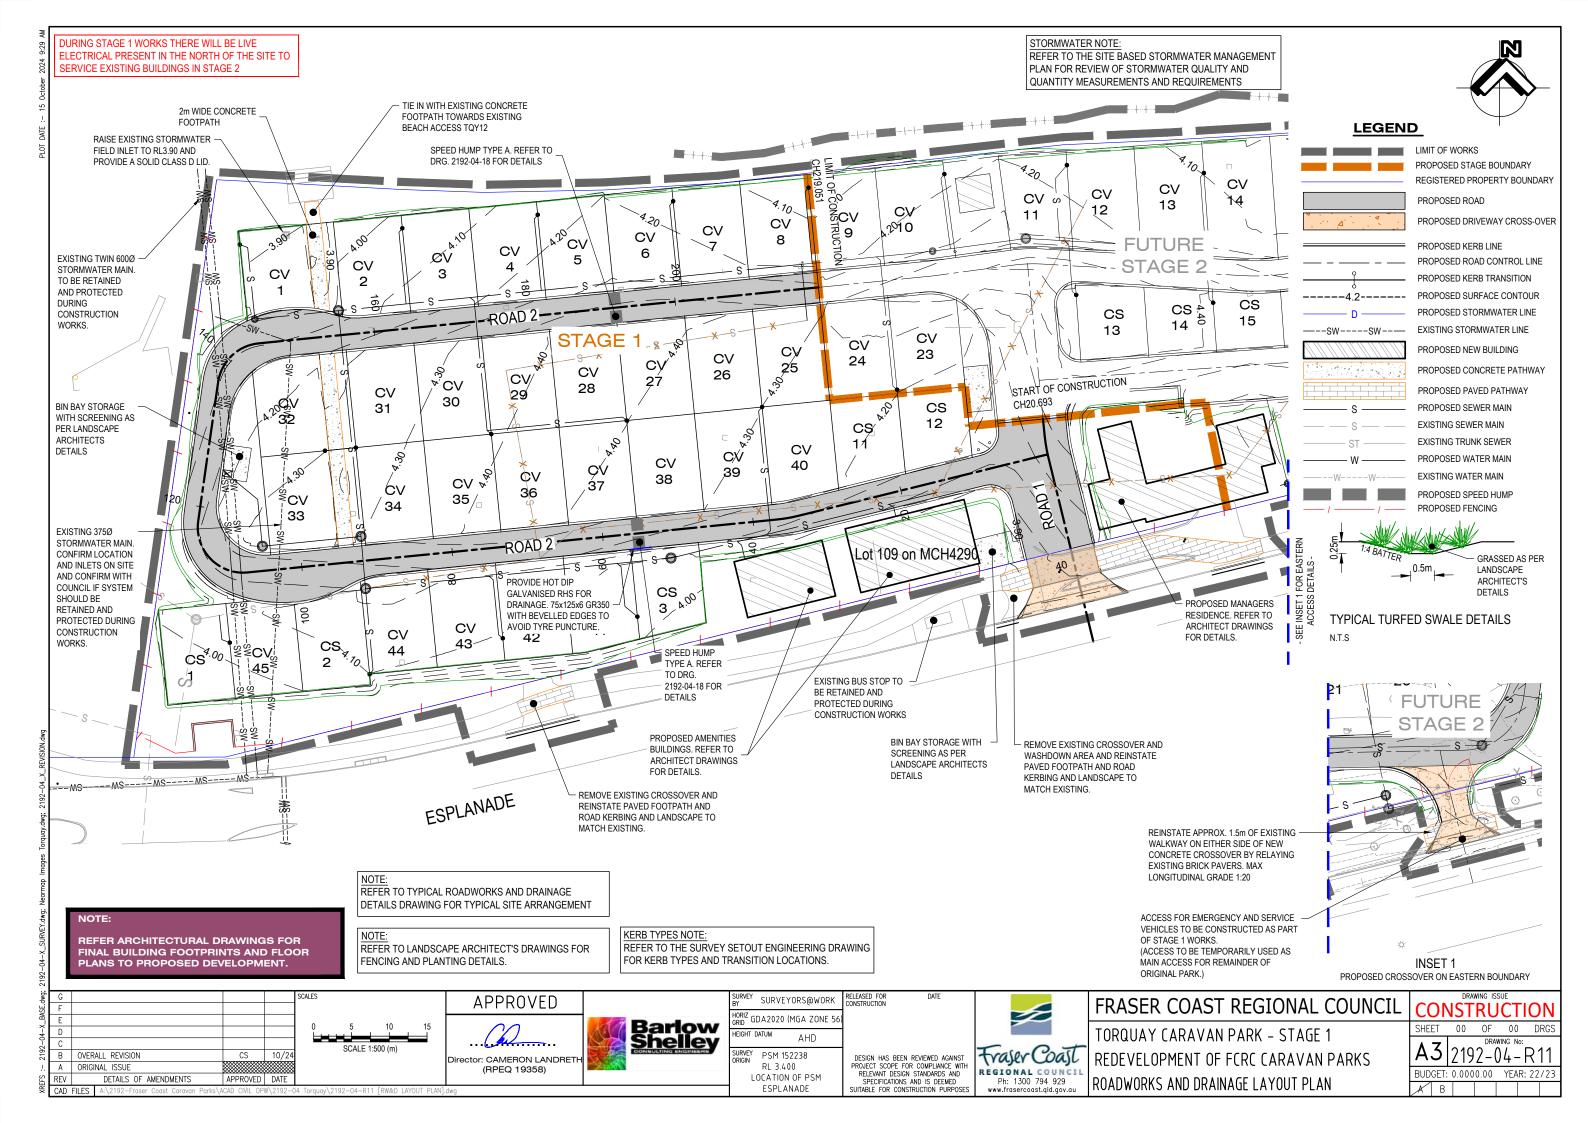

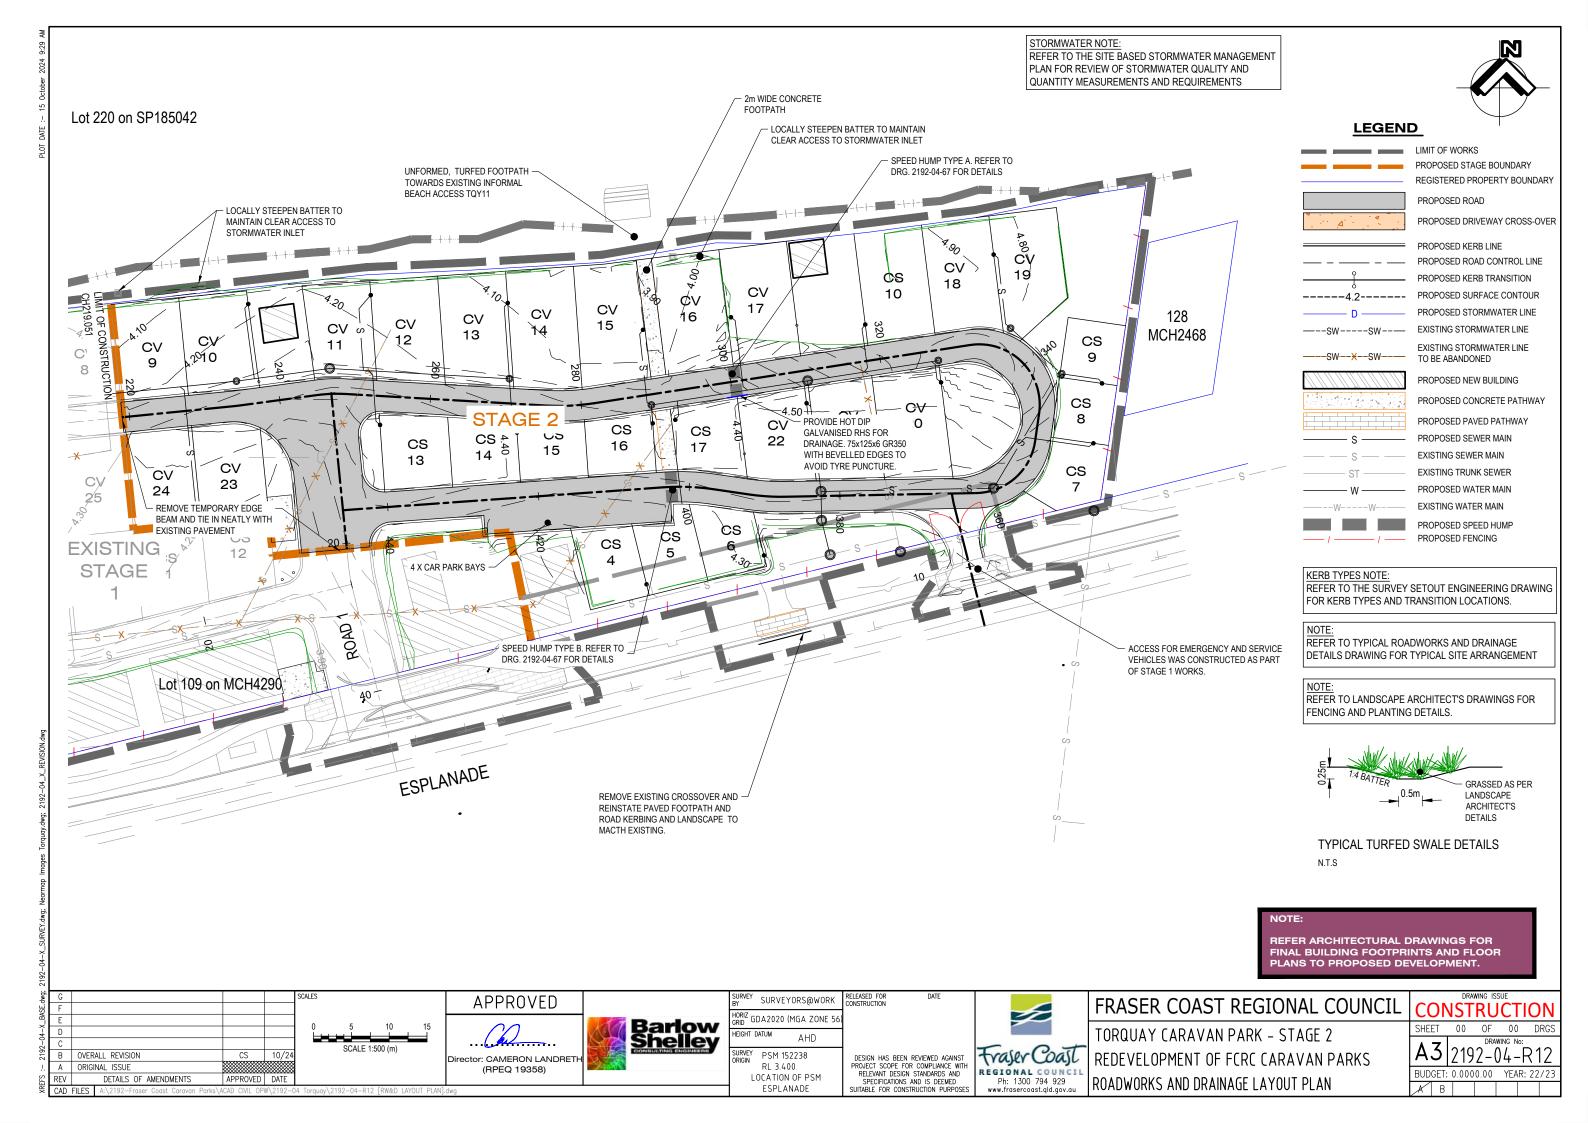



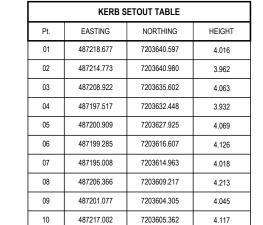


7203606.662

4.164

487221.023

	CROSSOVE	R SETOUT TABLE			
Pt.	EASTING	HEIGHT			
20	487306.441	7203608.612	exist		
21	487315.180	7203610.765	exist		
22	487307.360	7203604.846	3.864		
24	487306.372	7203602.550	3.806		
25	487305.231	7203600.885	3.821		
26	487305.814	7203601.026	3.689		
27	487305.850	7203600.880	3.678		
28	487305.265	7203600.739	3.671		
29	487319.263	7203604.123	3.719		
30	487319.847	7203604.264	3.718		
31	487319.811	7203604.409	3.868		
32	487319.228	7203604.269	3.728		
33	487318.036	7203605.369	3.821		
34	487316.118	7203606.953	3.879		

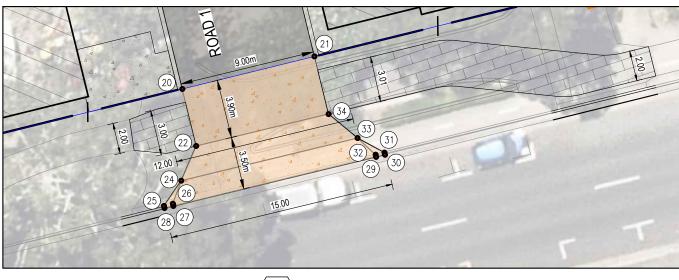

LEGEND

PROPOSED ROAD

PROPOSED DRIVEWAY CROSS-OVER
PROPOSED ROAD KERB

PROPOSED ROAD CONTROL LINE
PROPOSED NEW BUILDING

PROPOSED PATHWAY

NOTE:

REFER TO DRAWING 2192-04-R16 FOR
 LONGITUDINAL SECTIONS OF KERB RETURNS
 AND SETOUT TABLES

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DETAIL

APPROVED

Director: CAMERON LANDRETH (RPEQ 19358)



SURVEY SURVEYORS@WORK CONSTRUCTION

TORIZ GDA 2020 (MGA ZONE 56)

HEIGHT DATUM AHD

SURVEY PSM 152238 DESIGN HAS

RL 3.400

LOCATION OF PSM

ESPLANADE

DESIGN HAS BEEN REVIEWED AGAINST PROJECT SCOPE FOR COMPLIANCE WITH RELEVANT DESIGN STANDARDS AND SPECIFICATIONS AND IS DEEMED SUITABLE FOR CONSTRUCTION PURPOSES




FRASER COAST REGIONAL COUNCIL

TORQUAY CARAVAN PARK - STAGE 1
REDEVELOPMENT OF FCRC CARAVAN PARKS
INTERSECTION DETAILS SHEET 1 OF 3

DRAWING ISSUE	
CONSTRUCTION	DI

A3 2192-04-R24



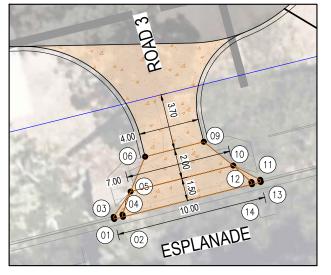

	CROSSOVER	SETOUT TABLE S	Г 2
Pt.	EASTING	NORTHING	HEIGHT
01	487386.820	3.893	
02	487387.403	3.894	
03	487386.784	4.043	
04	487387.366	3.902	
05	487387.907	7203622.776	3.991
06	487388.871	7203625.083	4.051
09	487392.748	7203626.064	4.155
10	487394.693	7203624.493	4.127
11	487396.479	7203623.553	4.058
12	487395.897	7203623.405	3.926
13	487396.515	7203623.407	3.908
14	487395.934	7203623.260	3.907

	RC	OAD ST 2	
Pt.	EASTING	NORTHING	HEIGHT
20	487390.737	7203656.145	4.785
21	487402.165	7203644.842	4.492
22	487401.639	7203641.175	4.387
23	487395.415	7203633.295	4.238
24	487389.386	7203651.888	4.903
25	487397.952	7203643.655	4.559
26	487388.959	7203636.539	4.303
27	487351.461	7203633.099	4.276
28	487351.557	7203630.901	4.161
29	487327.247	7203629.175	4.200
30	487327.091	7203631.370	4.244

LEGEND

PROPOSED ROAD


PROPOSED DRIVEWAY CROSS-OVER

PROPOSED ROAD KERB PROPOSED NEW BUILDING

PROPOSED ROAD CONTROL LINE

PROPOSED PATHWAY

REFER TO DRAWING 2192-04-R65 FOR LONGITUDINAL SECTIONS OF KERB RETURNS AND SETOUT TABLES

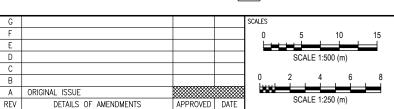

DETAIL

APPROVED ector: CAMERON LANDRETH

(RPEQ 19358)



LOCATION OF PSM ESPLANADE

RELEASED FOR CONSTRUCTION JRVEY SURVEYORS@WORK HORIZ GRID GDA2020 (MGA ZONE 56 AHD PSM 152238 RL 3.400


Fraser Coast DESIGN HAS BEEN REVIEWED AGAINST PROJECT SCOPE FOR COMPLIANCE WITH RELEVANT DESIGN STANDARDS AND SPECIFICATIONS AND IS DEEMED SUITABLE FOR CONSTRUCTION PURPOSES REGIONAL COUNCIL


FRASER COAST REGIONAL COUNCIL


TORQUAY CARAVAN PARK - STAGE 2 REDEVELOPMENT OF FCRC CARAVAN PARKS INTERSECTION DETAILS SHEET 2 OF 3

CONSTRUCTION

SHEET 00 OF 00 DRGS BUDGET: 0.0000.00 YEAR: 22/23

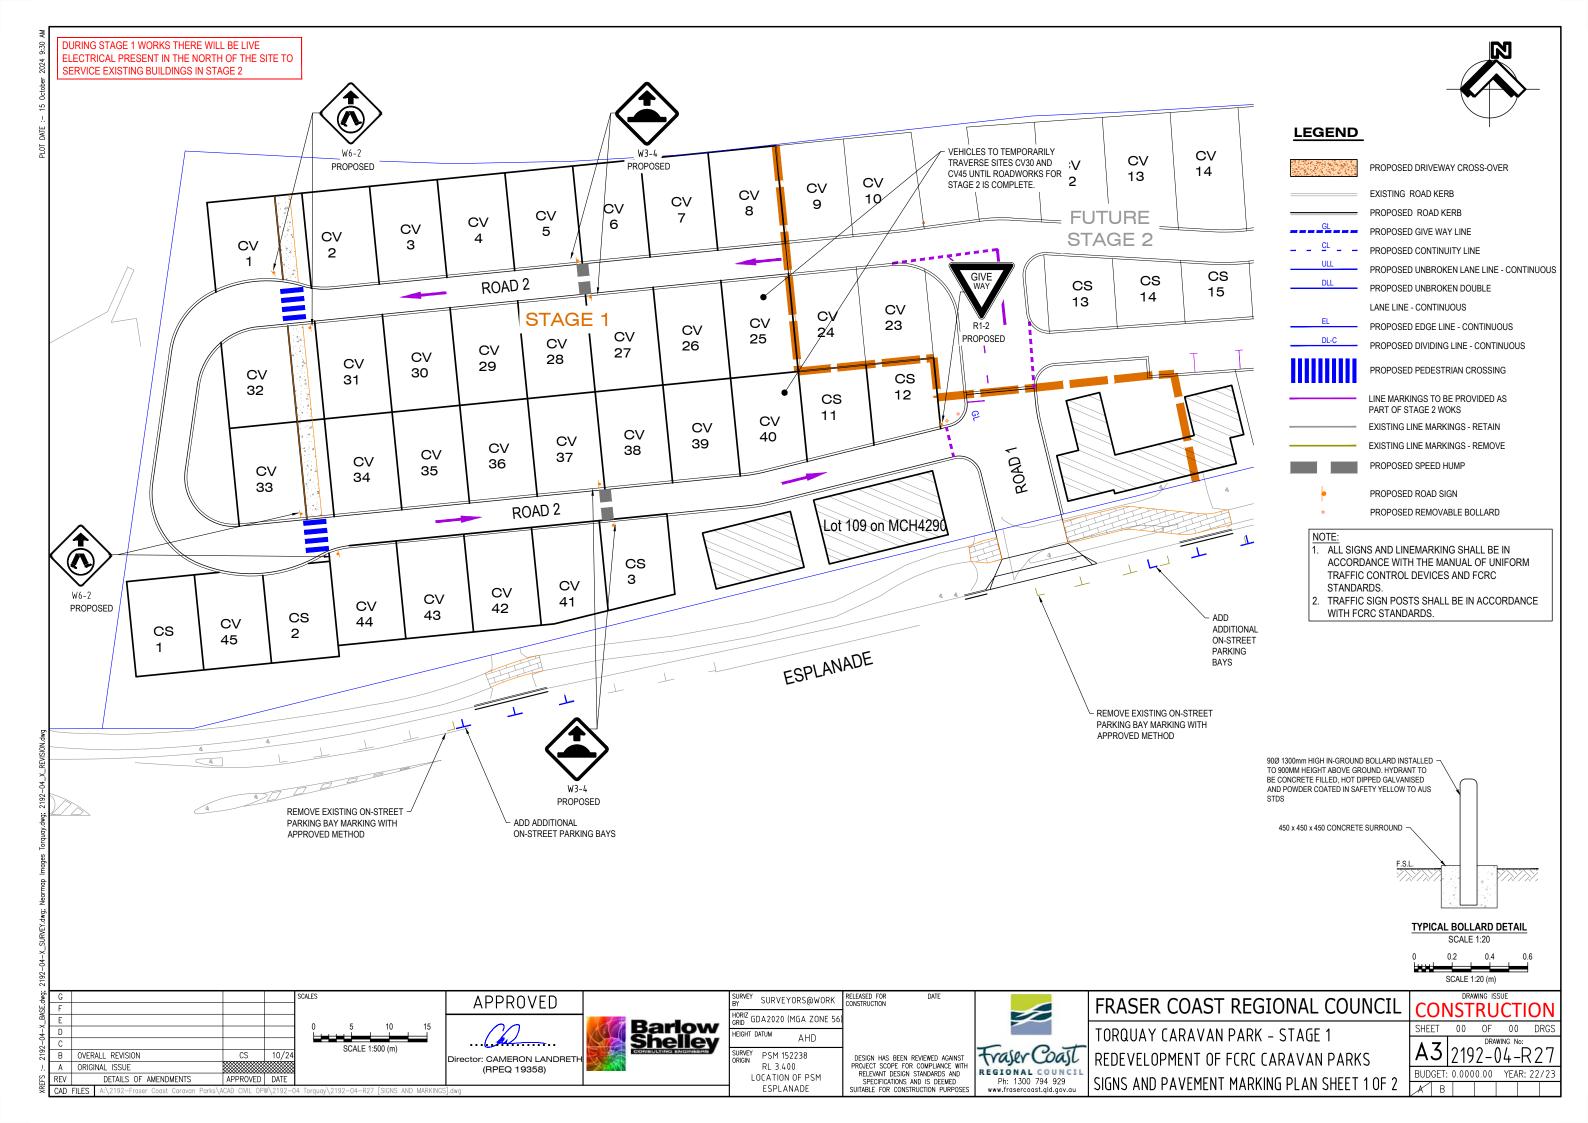

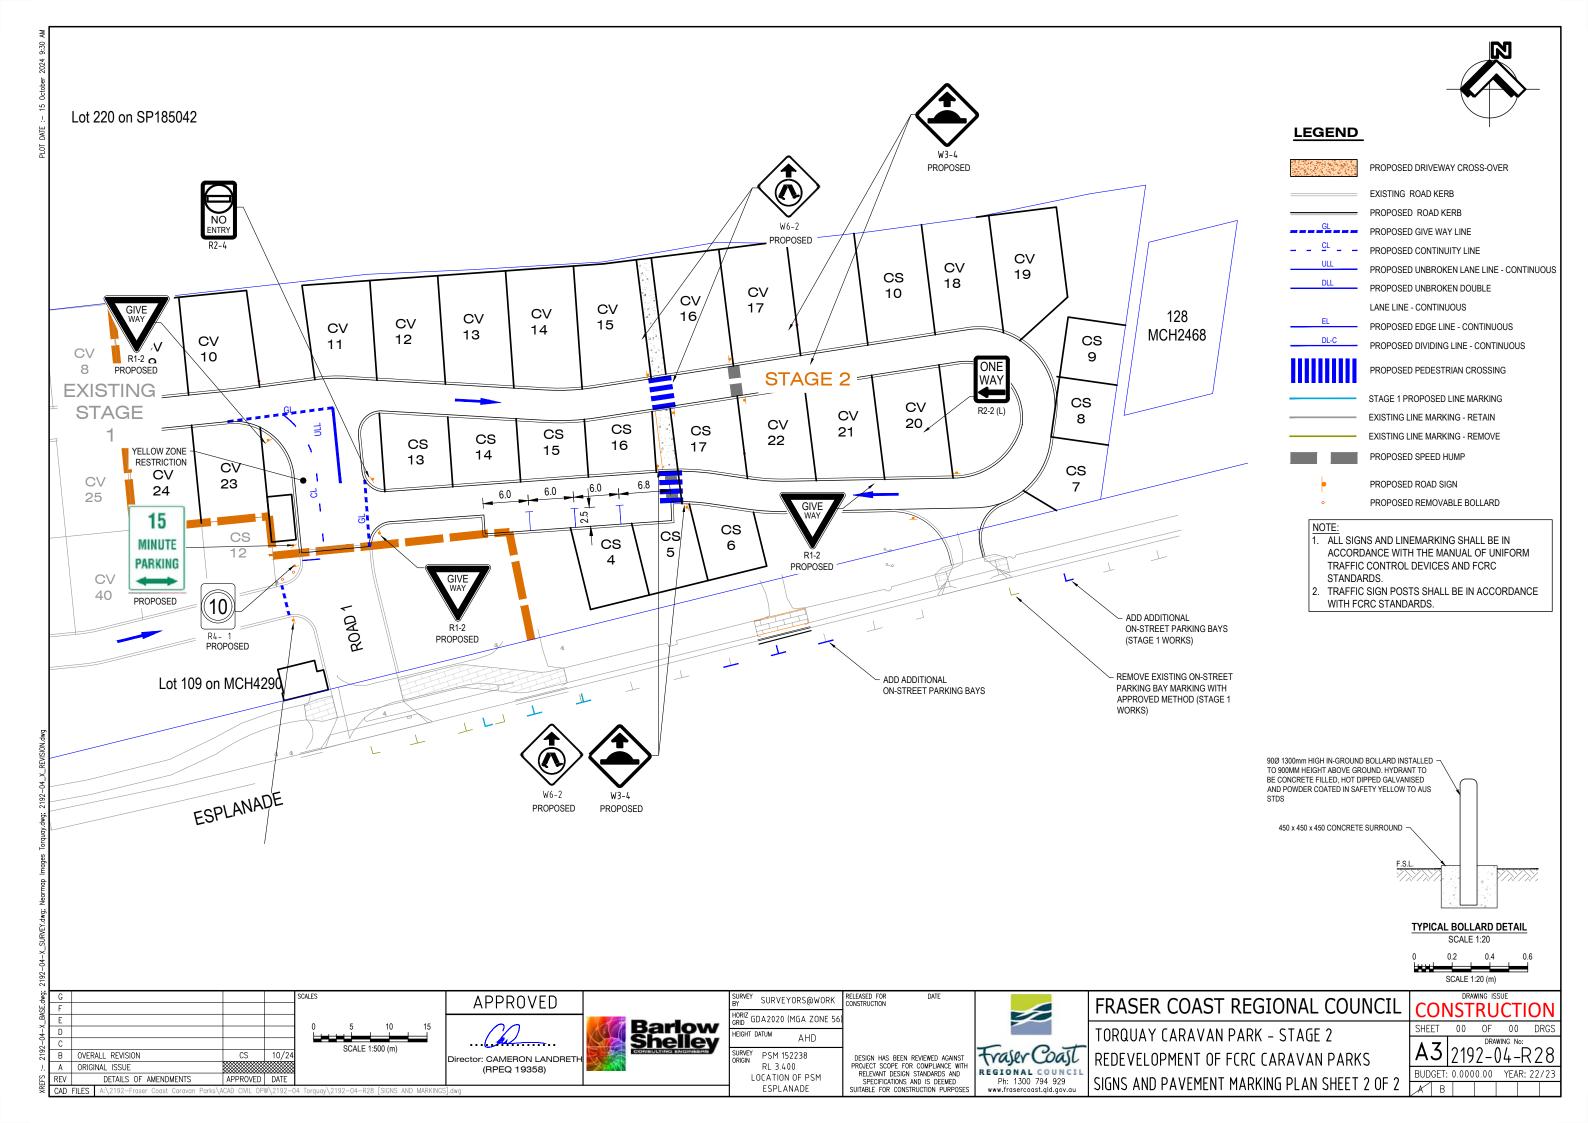

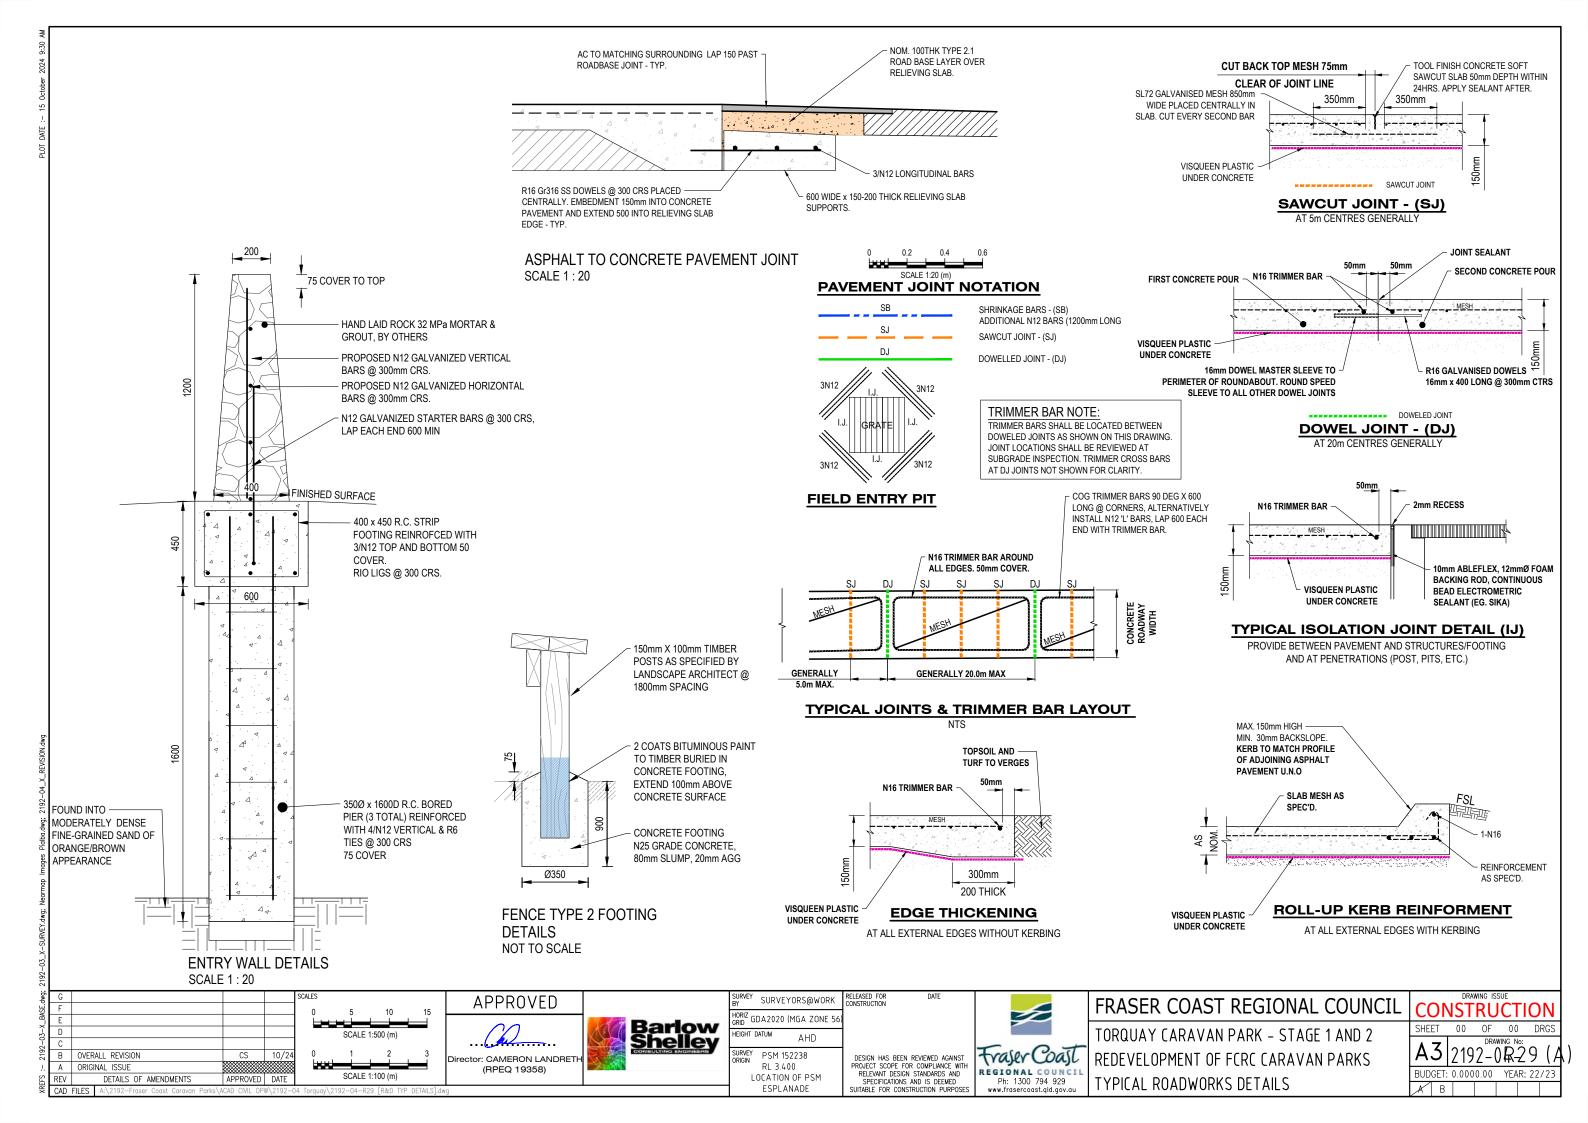



MACKS RD PLASS



SCHEDULE OF DRAWINGS

DWG	DESCRIPTION
2912-04-R31	SEWER LOCALITY PLAN AND NOTES
2912-04-R34	SEWER RETICULATION LAYOUT PLAN
2912-04-R38	SEWER LONGITUDINAL SECTION SHEET 4 OF 7
2912-04-R39	SEWER LONGITUDINAL SECTION SHEET 5 OF 7
2912-04-R40	SEWER LONGITUDINAL SECTION SHEET 6 OF 7
2912-04-R41	SEWER LONGITUDINAL SECTION SHEET 7 OF 7
2912-04-R42	SOIL- AND SULLAGE POINT DETAILS

ST

ROBERT

EXISTING MANHOLE LOCATIONS AND LEVELS TO BE CONFIRMED ON SITE PRIOR TO CONSTRUCTION

XISTING SERVICES THE CONTRACTOR IS TO DETERMINE THE EXACT OCATION OF ALL EXISTING SERVICES IN THE VICINITY OF THE ROPOSED WORKS PRIOR TO THE START OF ANY CONSTRUCTION HE COST OF ANY RECTIFICATION WORKS DUE TO DAMAGE TO XISTING SERVICES SHALL BE BORNE BY THE CONTRACTOR

NAME OF ESTATE		PIALBA TOURIST PARK				
SUBDIVER		FRASER COAST REGIONAL COUNCIL				
APPLICATION No.						
SP DELEGATE APPROVAL DATE						
DRAWING/PLAN No.		2192-04-R31, R34, R38-R42				
No. OF SITES		17				
AREA IN Ha.		0.475Ha				
LENGTH OF	100mm	126m				
SEWERS	150mm	165m				

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SCALE 1:5000

ST

PROPERTY DESCRIPTION

LOT 109 ON MCH4290 ESPLANADE, TORQUAY SITE AREA =0.475HA

	SERVICE PROVIDER AND CONSTRUCTOR LIVE WORKS SCHEDULE									
No.	DESCRIPTION	DIA. SEWER	MH NO.	MH/MS TYPE	COVER TYPE	LOT NO.	F.S.L.	E.S.L.	I.L.	DEPTH TO INVERT
1 (A)	0.5m FROM TEMPORARY STUB PROVIDED IN STAGE 1, CONSTRUCTOR TO LAY LINES 10, 13 AND 14 AND INSTALL CONNECTIONS.									
1 (B)	AFTER SUCCESSFUL "ON MAINTENANCE" INSPECTION OF LINES 10, 13 AND 14, CONSTRUCTOR, UNDER SUPERVISION OF WBW, TO REMOVE END CAP ON LINE 10 STUB, AND MAKE LIVE CONNECTION.	150	ROAD VERGE				4.148	4.148	3.181	0.967
2 (A)	0.5m FROM STUB END, CONSTRUCTOR TO LAY FINAL PORTION OF LINE 1. AFTER, CLEANSING, TESTING AND INSPECTING, NOTIFY WBW	150	-	-	-	CV8	4.187	4.144	2.604	1.583
2 (B)	CONSTRUCTOR, UNDER SUPERVISION OF WBW, TO REMOVE END CAP ON STUB, REMOVE CONNECTION LINE FROM CV30 AND MAKE LIVE CONNECTION AFTER SUCCESFUL "ON MAINTENANCE" INSPECTION.	0					0.000	0.000	0.000	0.000
2 (C)	DEMOLISH AND REMOVE EXISTING MANHOLE ON CV30.	0					0.000	0.000	0.000	0.000

GENERAL NOTES

- PRE-DISTURBED SOIL PROFILES AND COMPACTION LEVELS SHALL BE REINSTATED.
- PRE-DISTURBED VEGETATION PATTERNS SHALL BE RESTORED.

VEGETATION PROTECTION

- WHEN WORKING WITHIN THE TREE PROTECTION ZONE OF RETAINED TREES FULL TIME ARBORIST SUPERVISION IS REQUIRED. STAR PICKETS AND ORANGE BARRIER MESH TO BE INSTALLED AROUND THE STRUCTURAL ROOT ZONE OF TREES TO PROTECT THE TREES FROM PLANT AND MATERIAL COMPACTION.
- IF ROOTS ARE SEVERED THE DAMAGED AREA SHALL BE TREATED WITH A SUITABLE FUNGICIDE. CONTACT RELEVANT ARBORIST FOR FURTHER ADVICE. ANY TREE LOPPING REQUIRED SHOULD BE UNDERTAKEN BY AN APPROVED

- TOPSOIL AND SUBSOIL SHALL BE STOCKPILED SEPARATELY.
 CARE SHALL BE TAKEN TO PREVENT SEDIMENT FROM ENTERING THE STORMWATER SYSTEM. THIS MAY INVOLVE PLACING APPROPRIATE SEDIMENT CONTROLS AROUND STOCKPILES
- THE RISK OF ENCOUNTERING POTENTIAL ACID SULFATE SOIL (PASS) WHERE EXCAVATION IS EXPECTED BELOW 5m AHD IS CONSIDERED HIGH. SITE INVESTIGATION HAS INDICATED THAT THE INSITU SOILS ARE PREDOMINANTLY FINE / NON COHESIVE SANDS AND PASS HAS NOT BEEN ENCOUNTERED DURING THE GEOTECHNICAL INVESTIGATION AND PASS ASSESSMENT WAS NOT UNDERTAKEN. SHOULD PASS BE ENCOUNTERED ON SITE DURING CONSTRUCTION, THE SOILS SHALL BE ASSESSED BY A SUITABLY QUALIFIED PERSON WITH EXPERIENCE IN IDENTIFYING PASS. ANY PASS IS IDENTIFIED ON SITE SHALL BE TESTED AND ALL PASS MATERIALS EXCAVATED OR OTHERWISE DISTURBED DURING CONSTRUCTION SHALL BE TREATED TO NEUTRALISE THE RESPECTIVE ACIDITY PRESENT.

SAFETY

THE DESIGN AND CONSTRUCTION OF THE WORKS SHALL COMPLY WITH ALL QUEENSLAND LEGISLATION.

SEWER RETICULATION NOTES

- ALL WORK AND MATERIALS SHALL BE IN ACCORDANCE WITH CURRENT WIDE BAY BURNETT REGIONAL ORGANISATION OF COUNCILS SEWERAGE CODE SPECIFICATIONS AND STANDARDS.
- UNLESS SPECIFIED OTHERWISE ALL MATERIALS AND WORK SHALL COMPLY WITH THE RELEVANT AUSTRALIAN STANDARDS.
- THE CONSTRUCTION OF THE SEWERAGE WORK SHOWN ON THIS DRAWING SHALL BE SUPERVISED BY AN ENGINEER WHO HAS RPEO REGISTRATION SEWERAGE WORKS NOT COMPLYING WITH THIS REQUIREMENT WILL NOT BE PERMITTED TO CONNECT INTO THE WBBROC SERVICE PROVIDER SEWERAGE
- ALL WORK ASSOCIATED WITH LIVE SEWERS OR MAINTENANCE HOLES SHALL BE CARRIED OUT BY WIDE BAY WATER AT THE DEVELOPER'S COST.
- ALL PIPES AND MATERIALS SHALL COMPLY WITH THE REQUIREMENTS OF WIDE BAY WATER "ACCEPTED PRODUCTS AND MATERIALS" LIST.
- EACH NEW SITE SHALL BE SERVED BY A SHARED DN100 PVC PROPERTY CONNECTION AS INDICATED ON THE DRAWINGS.
- SITE CONNECTIONS SHALL BE LOCATED WITHIN THE SITE AS SHOWN IN THE
- SITE CONNECTION BRANCHES SHALL EXTEND INTO THE SITE AS INDICATED ON THE DRAWINGS.
- WHERE PIPES ARE LAID IN FILL, THE FILLING SHALL BE CARRIED OUT IN LAYERS NOT EXCEEDING 300mm (LOOSE) IN DEPTH AND SHALL BE COMPACTED UNTIL THE COMPACTION IS NOT LESS THAN 95% OF THE MATERIALS MAXIMUM COMPACTION WHEN TESTED IN ACCORDANCE WITH A.S. 1289 (MODIFIED COMPACTION). TESTING SHALL BE CARRIED OUT IN ACCORDANCE WITH COUNCIL REQUIREMENTS
- $\,$ G10 $\,$ Where sewers have a grade of 1 in 20 or steeper, bulkheads shall be CONSTRUCTED IN ACCORDANCE WITH THE WBBROC SEWER CODE.
- THE CONTRACTOR SHALL VERIFY THE LOCATION AND DEPTH OF EXISTING SERVICES WITH RELEVANT AUTHORITIES BEFORE COMMENCING WORKS.
- THE CONTRACTOR ARE TO CONFIRM THE MATERIAL TYPE OF EXISTING SERVICES AT THE PROPOSED CONNECTION POINT BEFORE COMMENCING WORKS.
- SEWERS SHALL BE DISUSED/ABANDONED IN ACCORDANCE WITH PROCEDURES SET OUT IN THE AS/NZS 3500.2 STANDARD.
- G14 BENCH MARK AND LEVELS TO AHD.
- G15 PLACE DETECTABLE MARKER TAPE OVER ALL SEWER MAINS.
- G16 ALL SEWER MAINS OF 150DIA OR GREATER TO UNDERGO CCTV INSPECTION.
- THE LOCATION AND DEPTH OF INTERNAL GRAVITY SYSTEMS (STORMWATER AND SEWERAGE) SHALL TAKE PRECEDENCE OVER ALL OTHER NON-GRAVITY SYSTEMS (WATER, ELECTRICAL, COMMS, GAS, ECT.), WHERE SERVICES CONFLICT IS IDENTIFIED ON-SITE, THE NON-GRAVITY SYSTEMS SHALL BE ADJUSTED TO SUIT THE SITE CONDITIONS AND NOT TO IMPACT ON THE GRAVITY

OVERALL REVISION DETAILS OF AMENDMENTS

SCALE 1:5000 (m)

APPROVED DATE

APPROVED r: CAMERON LANDRETH (RPEQ 19358)



^{JRVEY}SURVEYORS@WORK HORIZ GDA 2020 (MGA ZONE 5) IGHT DATUM AHD

PSM 152238 RL 3.400 LOCATION OF PSM

ESPLANADE

DESIGN HAS BEEN REVIEWED AGAINST PROJECT SCOPE FOR COMPLIANCE WITH RELEVANT DESIGN STANDARDS AND SPECIFICATIONS AND IS DEEMED SUITABLE FOR CONSTRUCTION PURPOSES

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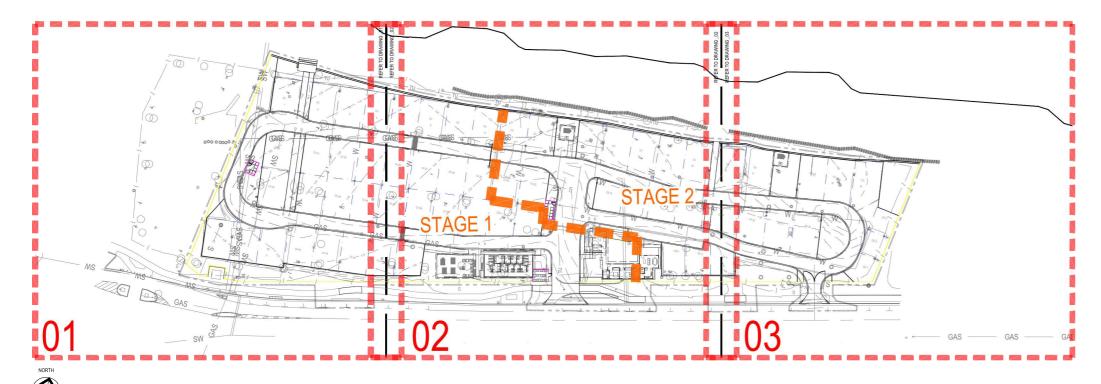
FRASER COAST REGIONAL COUNCIL

TORQUAY CARAVAN PARK - STAGE 2 REDEVELOPMENT OF FCRC CARAVAN PARKS SEWER AND WATER LOCALITY PLAN AND NOTES

CONSTRUCTION

SHEET 00 OF 00 DRGS

BUDGET: 0.0000.00 YEAR: 22/23



FOR CONSTRUCTION

SCHEDULE OF DRAWINGS

COVER SHEET - DRAWING SCHEDULE, SHEET LAYOUT PLAN GENERAL NOTES MATERIALS SCHEDULE PLANTING SCHEDULE	2022027-000 2022027-001 2022027-002 2022027-003
EXISTING TREES PLAN: SHEET 1 EXISTING TREES PLAN: SHEET 2 EXISTING TREES PLAN: SHEET 3	2022027-101 2022027-102 2022027-103
SURFACES PLAN: SHEET 1 SURFACES PLAN: SHEET 2 SURFACES PLAN: SHEET 3	2022027-201 2022027-202 2022027-203
PLANTING PLAN: SHEET 1 PLANTING PLAN: SHEET 2 PLANTING PLAN: SHEET 3	2022027-601 2022027-602 2022027-603
HARDSCAPE DETAILS: SHEET 1 HARDSCAPE DETAILS: SHEET 2 HARDSCAPE DETAILS: SHEET 3 SOFTSCAPE DETAILS: SHEET 1	2022027-901-1 2022027-901-2 2022027-901-3 2022027-902-1



NOT TO SCALE

FRASER COAST CARAVAN PARKS - TORQUAY

FOR CONSTRUCTION

FRASER COAST REGIONAL COUNCIL

PROJECT NUMBER: 2022027 DATE: 06.09.2024

DRAWING NUMBER: 2022027-000 REVISION: 04

Level 1, 24 Duporth Avenue Maroochydore QLD 4558 T + 61 7 5499 6188

SUNSHINE COAST

GENERAL NOTES

NOTE: THIS LANDSCAPE PLAN MUST BE READ IN CONJUNCTION WITH THE APPROPRIATE STATUTORY APPROVALS AND AUSTRALIAN

- FOR MORE DETAIL REFER TO THE PROJECT ARCHITECT'S AND ENGINEER'S DRAWINGS.
- PLANTING SHOWN REFLECTS THE DESIGN INTENT, EXACT NUMBERS AND LOCATIONS WILL REQUIRE CONFIRMATION ON SITE BY THE SUPERINTENDENT. ANY CHANGES TO BE MADE TO THE LANDSCAPE PLAN MUST BE APPROVED BY THE LANDSCAPE ARCHITECT AND SUPERINTENDENT.
- ALL LANDSCAPE PLANS PRESENTED ASSUME THAT ALL BASE AND SURVEY INFORMATION IS ACCURATE AND TO SCALE. THE CONTRACTOR SHALL CHECK LANDSCAPE PLANS PRESENTED FOR ANY DISCREPANCIES WITH THE EXISTING SITE CONDITIONS OR OTHER DRAWINGS PRESENTED PRIOR TO ANY CONSTRUCTION WORK TAKING PLACE, IF DISCREPANCIES DO OCCUR THESE SHALL BE HIGHLIGHTED AT ONCE TO THE SUPERINTENDENT PRIOR TO ANY CONSTRUCTION WORK TAKING PLACE. DIMENSIONS

- THE CONTRACTOR SHALL:

 INSTALL SILT CONTROL AND VEGETATION PROTECTION FENCING AS REQUIRED.
- REMOVE ALL UNWANTED MATERIAL FROM LANDSCAPE WORK AREA. CONFIRM ALL DIMENSIONS ON SITE PRIOR TO CONSTRUCTION.
- SEEK INSTRUCTION FROM SUPERINTENDENT WHERE LEVEL DISCREPANCIES, SPECIFICATION SUBSTITUTIONS AND POOR SOIL

SERVICES

THE CONTRACTOR SHALL CONFIRM THE LOCATION OF ALL SERVICES WITH RELEVANT AUTHORITIES PRIOR TO PLANTING AND

ENSURE DRAINAGE WORKS CORRELATE WITH ADJACENT LAND AND SPECIFIED FINISHED LEVELS.

 INSTALL FIELD INLETS TO MANUFACTURER'S RECOMMENDATIONS AT LOCATIONS AND LEVELS INDICATED ON PLANS, FINISH SURFACE PIT LEVEL FLUSH WITH ADJACENT FINISHED SURFACE LEVELS, ENSURE POSITIVE OVERLAND DRAINAGE FLOW TO ALL PITS AND THAT NO PONDING OCCURS AROUND THE PIT. ALIGN ALL PITS SQUARE WITH TO PATHS, PAVEMENT PATTERNS, KERBS, WALLS AND ALIKE.

- INSTALL CONTINUOUS SUB-SURFACE DRAINAGE SYSTEM TO LOCATIONS AND LEVELS AS INDICATED ON PLANS. SUB-SOIL DRAINS SHALL INCORPORATE A TRENCH WITH A GEOTEXTILE LINING, DRAINAGE GRAVEL BACKFILL MATERIAL AND A 100MM SLOTTED AG-PIPE TO THE FOLLOWING SPECIFICATION:
- GEOTEXTILE MATERIAL: GEOTEXTILE MATERIAL SHALL BE A NON-WOVEN TYPE AND SHALL HAVE A STRENGTH RATING (G) OF
- BACKFILL MATERIAL: 20MM DRAINAGE AGGREGATE IN ACCORDANCE WITH AS 2758 1988.
- DRAINAGE PIPES: 100MM Ø SLOTTED AG-PIPES SHALL COMPLY WITH AS 2439-PART 1 "PERFORATED DRAINAGE PIPE AND ASSOCIATED FITTINGS". PERFORATIONS SHALL NOT EXCEED 0.7MM IN DIAMETER OR WIDTH.

- SITE SHALL BE POSITIVELY DRAINED, I.E. NO PONDING AREAS, 2% MINIMUM TO PITS OR LEGALLY SHEET FLOWING OFF-SITE.
- MULCHED GARDEN BED AREAS SHOULD NOT EXCEED A 1:3 GRADE AND TURF AREAS SHOULD NOT EXCEED A 1:4 GRADE. FINAL GRADE EXISTING TOP 100MM AND TRIM TO +/-10MM TO ACHIEVE PLAN LEVELS.

- COLLECT TOPSOIL SAMPLE(S) AND HAVE IT TESTED BY A NATA CERTIFIED LAB FOR HORTICULTURAL SUITABILITY, I.E. PLANTING TREES AND TURF. FURNISH TEST RESULTS TO LANDSCAPE ARCHITECT.
- CULTIVATE GARDEN AND TURF AREAS 150MM DEEP.
 AMELIORATE SUBGRADE AND SITE TOPSOILS PER TESTING RESULTS.
- AMELIORATE SIDERADE AND STITE FOR SIGNED FEAT TO STITE OF SOILS OF A PAPER OF THE TOPS OIL THAT COMPLIES WITH MRTS 16 (MAIN ROADS TECHNICAL SPECIFICATION) TO PLANTING AREAS IF AMELIORATED SITE TOPS OIL IS NOT AVAILABLE.
- ALL SOIL STOCKPILES ARE TO BE MAINTAINED TO CONTROL WEEDS ROUTINELY AND GUARD AGAINST DISPERSION BY WIND OR WATER. STOCKPILES SHALL BE LIMITED TO A MAXIMUM HEIGHT OF 2M AND MAY REQUIRE COVERING OR RETAINING. STOCKPILES ARE NOT PERMITTED WITHIN CLOSE PROXIMITY TO RESIDENTIAL PROPERTIES.
- GENERALLY SOIL TO BE USED SHALL COMPLY WITH THE FOLLOWING SPECIFICATION; FRIABLE AND FREE DRAINING SANDY LOAM
- GOOD TEXTURE AND STRUCTURE FOR SELECTED USE
 ACCEPTABLE CONDUCTIVITY AND PH LEVELS FOR SPECIFIED PLANTS

CONCRETE

REFER TO FINISHES SCHEDULE AND ENGINEER'S AND ARCHITECT'S PLANS RESPECTIVELY.

INSTALL EDGING TO ALL GARDEN BEDS AND TURF JUNCTIONS AS PER FINISHES SCHEDULE AND DETAIL.

- ALL MULCH PROPOSED TO BE USED ON SITE SHALL BE FREE OF DELETERIOUS MATERIALS AND FOREIGN MATTER INCLUDING ANTHROPOGENIC WASTE, ROCK, SOIL, SEDIMENT CONTAMINATION, WEEDS AND STICKS.
- MULCH GARDEN AREAS 100MM DEEP SETTLED, KEEPING 50MM CLEAR OF PLANT STEMS, TO ENSURE SITE WATER
- CONSERVATION REQUIREMENTS ARE ACHIEVED.

GENERAL PLANTING

- PLANT STOCK IS TO BE APPROVED BY CONTRACTOR AND QUALIFIED ARBORIST PRIOR TO ACCEPTANCE OF DELIVERY.
- FOR DEEP PLANTING AREAS, EXCAVATE GARDEN AREAS TO A DEPTH OF 300MM, CULTIVATE SUBGRADE TO A DEPTH OF 150MM AND TREAT AS PER SOILS TESTING RESULTS.
- INSTALL AMELIORATED SITE TOPSOIL OR SPECIFIED TOPSOIL 300MM DEEP, SETTLED, AND MULCH AS SPECIFIED. NO SYNTHETIC, GRANULAR BLENDED FERTILISERS TO BE USED ON SITE. SLOW RELEASE ORGANIC TREE TABLETS SHALL BE USED AT ESTABLISHMENT. ALL PLANTINGS SHALL INCORPORATE THE INCLUSION OF A SLOW RELEASE NATIVE PLANT FERTILIZER (AS PER
- MANUFACTURERS SPECIFICATION) AND THE USE OF A SOIL MOISTURE RETENTION ADDITIVE (AS PER MANUFACTURERS SPECIFICATION), PLACED ADJACENT THE PLANT ROOT BALL AT THE TIME OF PLANTING. TREES >25 LITRE BAGS ARE TO BE CERTIFIED BY A QUALIFIED ARBORIST AS AS2013:2105 COMPLIANT PRIOR TO DELIVERY TO SITE. QUALIFIED ARBORIST TO SELECT AS2013:2105 COMPLIANT TREES AT NURSERY AND PDG (IF REQUIRED) TO CHECK ON DELIVERY TO SITE. FURNISH CERTIFICATION TO SUPERINTENDENT AND LANDSCAPE ARCHITECT PRIOR TO PRACTICAL
- COMPLETION. DO NOT INSTALL TREES WITHIN:
- 1M OF UNDERGROUND SERVICES
 1.5 OF SEWERS, HORIZONTALLY AND VERTICALLY
- 3M OF DRIVEWAY CROSSOVERS
 4M OF STREET LIGHTS AND POWER POLES
- 15M OF BUS STOPS ARRIVAL SIDE

WHERE DIFFERENT GROUNDCOVERS ARE PLANTED IN MASSES, TRIANGULARLY SPACE THEM EQUIDISTANT PER SPECIES AND PLANT THEM IN ODD NUMBERED GROUPS

- EXCAVATE TURF AREAS TO A DEPTH OF 150MM, CULTIVATE SUBGRADE TO A DEPTH OF 150MM AND TREAT AS PER SOILS TESTING RESULTS.
- INSTALL 150MM OF AMELIORATED SITE TOPSOIL OR IMPORTED TOPSOIL AS SPECIFIED.
- FINISHED TURF GRADES/CONTOURS TO BE GENERALLY SMOOTH, COORDINATE ON SITE WITH SUPERINTENDENT AND ENSURE
- TURF LAID ON LOW SIDE OF HARD SURFACES SHALL BE 20MM BELOW ADJACENT HARD SURFACE TO NOT IMPEDE STORM
- SUPPLY AND LAY TURE AS INDICATED ON THE DRAWINGS.
- WATER TURF IN WELL AND REFER TO SUPPLIERS MAINTENANCE REQUIREMENT FOR ESTABLISHMENT.
- APPLY WATER TO MAINTAIN SOIL MOISTURE UNTIL ESTABLISHED DURING MAINTENANCE PERIODS TO MAINTAIN VIBRANT GREEN TURF COLOUR AND HEALTH.

- LANDSCAPE CONSTRUCTION CONTRACTOR TO MAINTAIN WHOLE OF LANDSCAPE WORKS FOR ESTABLISHMENT PERIOD OF 13 WEEKS AND HAND OVER TO OWNER ONCE COMPLETED.
- THE FOLLOWING TASKS ARE TO BE ACTIONED DURING ESTABLISHMENT AND IN PERPETUITY;

- EVERY DAY FOR THE FIRST TWO WEEKS (UNI ESS IT RAINS ADEQUATELY)
- EVERY 2-3 DAYS DURING THE BALANCE OF THE ESTABLISHMENT PERIOD OR AS NEEDED IF HOT AND DRY (UNLESS IT RAINS ADFQUATFLY)
- ONCE A WEEK THERE AFTER.

TURF MOWING

- FIRST MOW ONCE AFTER 10 DAYS IF THERE IS RAPID GROWTH OR 14 DAYS AFTER INSTALLATION.
 MOWING THEREAFTER ONCE A WEEK DURING SUMMER, ONCE EVERY TWO WEEKS IN SPRIN SPRING AND AUTUMN, AND ONCE A MONTH IN WINTER OR AS REQUIRED IF THERE IS A LOT OF GROWTH OR AS DESIRED.

AS REQUIRED. MAINTAIN 5MM GAP BETWEEN TURF AND HARD SURFACES.

- TURF AERATION AND TOPDRESSING

 AS REQUIRED TYPICAL TIMING IS END OF OCTOBER (SPRING) AND END OF FEBRUARY (AUTUMN).
- AERATE 100MM DEEP, 50MM O.C. WITH 16MM TINE (CORER).
 COLLECT PLUGS AND DISPOSE ENSURING THEY DO NOT GET REINCORPORATED INTO HOLES. TOPDRESS WITH TURF TOPSOIL NOMINATED IN FINISHES SCHEDULE - BRUSH TOPSOIL IN WITH BROOM.

ADDITIONAL MAINTENANCE TASKS

- WEED REMOVAL AND WICK WIPING: AS REQUIRED TO REDUCE COMPETITION AND SEEDING.
- PLANT REPLACEMENT: IMMEDIATELY REPLACE PLANTS THAT DIE OR FAIL TO THRIVE, ARE DAMAGED OR STOLEN, WITH PLANTS OF THE SAME SPECIES AND OF SIMILAR SIZE AND QUALITY LINLESS OTHERWISE SPECIFIED.
- STAKES AND GUYS: ADJUST AND/OR REPLACE STAKES AND TIES WHERE REQUIRED. REMOVE STAKING AND GUYING WHEN INSTRUCTED BY THE SUPERINTENDENT.
- RE-MULCHING: AS REQUIRED TO MAINTAIN A CONSISTENT DEPTH, 100MM SETTLED, UNTIL PLANTS ARE ESTABLISHED.
- TRIM / PRUNE PLANTS TO REMOVE DEAD, DYING AND DISEASED GROWTH AND FOR CHARACTER AND FORM AS REQUIRED.
 MONITORING: PROVIDE A MONTHLY REPORT ON COMPLETED TASKS.

WARRANTIES

- WARRANTIES OR GUARANTEES SPECIFIED SHALL NAME THE PRINCIPAL AS WARRANTEE. REGISTER WITH MANUFACTURERS AS NECESSARY. RETAIN COPIES DELIVERED WITH AND COMPONENTS AND EQUIPMENT TO THE PRINCIPAL.
- WARRANTIES AND/OR GUARANTEES TO BE SUBMITTED TO THE SUPERINTENDENT FOR TRANSMISSION TO THE PRINCIPAL WITHIN FOURTEEN (14) DAYS AFTER PRACTICAL COMPLETION
- COMMENCE WARRANTY PERIODS AT PRACTICAL COMPLETION OR AT ACCEPTANCE OF INSTALLATION, IF ACCEPTANCE IS NOT CONCURRENT WITH PRACTICAL COMPLETION.
- IF INSTALLATION IS NOT BY MANUFACTURER AND PRODUCT WARRANTY IS CONDITIONAL ON THE MANUFACTURER'S APPROVAL OF THE INSTALLER. SUBMIT THE MANUFACTURER'S WRITTEN APPROVAL OF THE INSTALLING FIRM.

PROVIDE AS2013:2105. MRTS 16 TOPSOIL. MULCH. AND TURF CERTIFICATIONS TO SUPERINTENDENT AND LANDSCAPE. ARCHITECT PRIOR TO PRACTICAL COMPLETION.

DELIVERABLES

- WARRANTIES
- TWO QUICK COUPLER KEYS
 - IRRIGATION SYSTEM AS-BUILT PLANS IN .DWG AND PDF FORMATS AND MAINTENANCE MANUAL

SOURCES

- SURVEY CIVIL ENGINEERING - Barlow Shelley
- ARCHITECTURE -ELECTRICAL ENGINEERING - Alight Consultants
- HYDRAULICS

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PROJECT.

Fraser Coast Regional Council

NOTES

CONSTRUCTION

ISSUE CODE ISSUE DESCRIPTION BY CHK DATE

OODL	IGGGE DEGGIGI TION	101	Ornic	DATE
PRE	PRELIMINARY	PA	VS	10/11/2022
CON	CONSTRUCTION	PA	٧S	08/02/2023
CON	CONSTRUCTION	PA	٧S	14/03/2023
CON	CONSTRUCTION	PA	VS	06/09/2023
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DRAWING TITLE

GENERAL NOTES

DESIGN : JB DOCUMENT : PA PROJECT : 2022027

NOT TO SCALE DRAWING NUMBER REVISION 2022027-001

FINISHES SCHEDULE

1.1	HARDSCAPE			
1.1				
	P1 - Pavement Type 1	Concrete Footpath	Material: Plain grey concrete Size: 125mm depth (to be confirmed br Civil Engineer) Finich: Broom finish Slip raiting: P4 slip raiting to AS 4586 Reinforcing: Refer to Engineer's Drawings Concrete Strength: Refer to Engineer's Drawings	Nominated by contractor to be approved by superintendent.
1.2	P2 - Pavement Type 2	Reinstated Footpath	Finish to match existing footpath along Esplanade	Nominated by contractor to be approved by superintendent.
1.3	Wall Type 1 (W1)	Entry Walls	Size: max 1.2m H (Rock Cobbles: Local Quarry, sound, free of machine marks, washed, 150-300nmØ+/-Rock Colour: as sourced Refer to details @901-1 for more information. Fixings: SAE 316L Marine Grade-Stainless Steel	Nominated by contractor to be approved by superintendent.
<u>04</u>			Mortar 32 MPa concrete. Grout Joints: Ultracolour Plus or approved similar (Colour: Black 120) Reinforcing, Concrete, Footings: Refer to engineer's drawings. Coordinate with other trades for lighting and electronic access items and respective installation specifications and requirements.	
1.4	Fence Type 1 (FT1)	Chain Wire Fence w/ Climbers	Fence: 2.5mm Hot-dip galvanized chain wire mesh Post: 75mm Ø Hot-dip galvanized steel pipe @ every 2000mm.o.c Top & Bottom Rait: 50mm Ø Hot-dip galvanized steel pipe Colour: black Dimensions: 1.2m where connects with Wall Type 1, everywhere else to be 1.8m High. Refer to detail @901-1	Nominated by contractor to be approved by superintendent.
1.5	Fence Type 2 FT2	Rail Type Fence	Material: HWD timber rail and posts (If preferred with HWD maintenance Edge. Detail can be added) Refer to Details @901-2	Nominated by contractor to be approved by superintendent.
1.6	Fence Type 3	Bin Enclosure	Material: HWD timber battens and posts Height: 1.2mm Refer to Details @901-3	Nominated by contractor to be approved by superintendent.
2	EDGING			
2.1	Garden Edge Type 1 EG1	Concrete Edge	Type: Plain Grey Concrete Edge. Size: 100mm wide x 150mm deep concrete extruded edge Finish: Broom finish Refer to Detail @901-3	Nominated by contractor to be approved by superintendent.
2.1	Garden Edge Type 2 EG2	Timber Edge	Material: H5 Treated Pine Edge and Stakes Colour: Natural Dimensions: 75mm wide x 100mm deep Fixing: Stainless steel Nails	Nominated by contractor to be approved by superintendent.
3	SOFTSCAPE			
3.1	Garden Bed Type 1 GB1	Deep planting areas in natural ground	PREP Excavate gardenbed areas 300mm deep and turf areas 150mm deep into existing ground. Cultivate subgrade 150mm. TOPSOIL Backfill garden areas 300mm - mounding in center with MRTS 16 topsoil. Refer to details. Provide soil testing results for topsoil and certification to landscape architect. MULCH Refer to Detail. Type: Tea Tree Mulch. Install 100mm deep settled to all garden bed areas. Ensure mulch is kept 50mm clear of plant stems.	Nominated by contractor to be approved by superintendent.
3.2	Turf Type 1 (T1)	Turf for camp sites	Refer to Detail. Type: Cynodon dactylon "Blue Couch", 'A' Grade, laid on 150mm topsoil as specified and where streetscape turf has been disturbed. Size: Rolls	Nominated by contractor to be approved by superintendent.
3.3	Turf Type 2	Turf for newly exposed areas outside of new fence line	Refer to Detail. Type: Cynodon dactylon "Blue Couch", 'A' Grade, laid on 150mm topsoil as specified and where streetscape turf has been disturbed. Size: Rolls	Nominated by contractor to be approved by superintendent.
3.4	Turf Type 3	Temporary turf	Refer to Turf type 1. To be converted to Garden Bed Type 1 when buildings are constructed	Nominated by contractor to be approved by superintendent.



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NOTES



ISSUE	CODE	ISSUE DESCRIPTION	BY	СНК	DATE
01	PRE	PRELIMINARY	PA	٧S	10/11/2
02	CON	CONSTRUCTION	PA	٧S	08/02/
03	CON	CONSTRUCTION	PA	٧S	14/03/
04	CON	CONSTRUCTION	PA	٧S	06/09/3
PRE - F	relimina	ary CA - Council Approval T -	Tender	COL	V - Cons

DRAWING TITLE

MATERIALS SCHEDULE

DESIGN : JB DOCUMENT : PA PROJECT : 2022027



REVISION 04 DRAWING NUMBER 2022027-002

PLANTING SCHEDULE - STAGE 1

YMBOL	CODEGEN	US / SPECIES - COMMON NAMEPOT SIZE	SIZE	QUANTITY	GROWTH RATI
REES					
+ ^{Bi}	BAN int	BANKSIA integrifolia - Coastal Banksia	45 L	5	SLOW
+Ce	CAS equ	CASUARINA equisetifolia - Beach She Oak	45 L	4	FAST
+Ct	COR tes	CORYMBIA tessellaris - Moreton Bay Ash	45 L	2	SLOW
+Ca	CUP ana	CUPANIOPSIS anacardioides - Tuckeroo	45 L	7	FAST
+cc	CAL col	CALLITRIS columellaris - Bribie Island Pine	45 L <u>/04</u> `	\ \	SLOW
$+^{Ht}$	H I B til	HIBISCUS tiliaceus - Beach Hibiscus	45 L	2	FAST
$+^{Pt}$	PAN tec	PANDANUS tectorius - Screw Pine	45 L 04	2	SLOW
HRUBS				_	
+Ac	ALP cae	ALPINIA caerulea - Native Ginger	140mm 04	59	
+Br	BAN rob	BANKSIA robur - Swamp Banksia	200mm	11	
⊣Bi	BLE ind	BLECHNUM indicum - Swamp Water Fern	200mm	87	
+ ^{Sa}	SYZ aus	SYZYGIUM australe - Lilly Pilly	200mm 04	40	
- W f	WES fru	WESTRINGIA fruticosa - Coastal Rosemary	200mm	25	
+ ^{Ha}	HOV acu	HOVEA acutifolia - Purple Pea Bush	140mm	23	
+ ^{Fgi}	FIC GI	FICUS 'Green Island'	200mm	44	
- ∆4t	MEL thy	MELALEUCA thymifolia - Thyme Honey-Myrtle	200mm /04	17	
∔ Ma	MEL aff	MELASTOMA affine	200mm	31	
₽sp	LEP pet	LEPTOSPERMUM petersonii	200mm	12	
LIMBERS	3				
∔ Ca	CIS ant	CISSUS antarctica - Kangaroo Vine	200mm 04	17	
₽tv	HAR vio	HARDENBERGIA violacea - Purple Coral Pea	200mm	19	
₽ Th	TEC hil	TECOMANTHE hillii - Fraser Island creeper	200mm 04	14	
ROUNDO	COVERS				
	CAR gla	CARPOBROTUS glaucescens	Tube	212	
}	BAL pal	BALOSKION pallens	Tube	23	
	LOM Ion	LOMANDRA longifolia	Tube	52	
+ ^{LH}	LOM hys	LOMANDRA hystrix	140mm	129	
{\\\\\\\\\\\\\\\\\\\\\\\\\\\\\\\\\\\\\	LOM ver	LOMANDRA verday	Tube	153	
	SCA aem	SCAEVOLA aemula - Fairy Fan-Flower	140mm	203	
} }	IPO pes	IPOMOEA pes-caprae	Tube	21	
} }	H I B sca	HIBBERTIA scandens	Tube	107	

PLANTING SCHEDULE - STAGE 2

SYMBOL	CODEGEN	IUS / SPECIES - COMMON NAMEPOT SIZE	SIZE	QUANTITY	GROWTH RATE
TREES					
+Bi	BAN int	BANKSIA integrifolia - Coastal Banksia	45 L	A 3	SLOW
+_Ce	CAS equ	CASUARINA equisetifolia - Beach She Oak	45 L	<u>/04</u> } 5 }	FAST
+Ct	COR tes	CORYMBIA tessellaris - Moreton Bay Ash	45 L	3	SLOW
+Ca	CUP ana	CUPANIOPSIS anacardioides - Tuckeroo	45 L	3	FAST
+cc	CAL col	CALLITRIS columellaris - Bribie Island Pine	45 L	5	SLOW
$+^{Ht}$	HIB til	HIBISCUS tiliaceus - Beach Hibiscus	45 L	04 } 7 }	FAST
$+^{Pt}$	PAN tec	PANDANUS tectorius - Screw Pine	45 L	4	SLOW
SHRUBS					
+Ac	ALP cae	ALPINIA caerulea - Native Ginger	140mm	39	
- Br	BAN rob	BANKSIA robur - Swamp Banksia	200mm	30	
+Bi	BLE ind	BLECHNUM indicum - Swamp Water Fern	200mm	\ \ 88 \	
+Sa	SYZ aus	SYZYGIUM australe - Lilly Pilly	200mm	<u>/04</u> } 9 {	
- W f	WES fru	WESTRINGIA fruticosa - Coastal Rosemary	200mm	32	
₽ ^{Ha}	HOV acu	HOVEA acutifolia - Purple Pea Bush	140mm	24	
+ ^{Fgi}	FIC GI	FICUS 'Green Island'	200mm	51	
- Mt	MEL thy	MELALEUCA thymifolia - Thyme Honey-Myrtle	200mm	28	
- Ma	MEL aff	MELASTOMA affine	200mm	<u>/04</u> } 31 }	
+ Lsp	LEP pet	LEPTOSPERMUM petersonii	200mm	9	
CLIMBERS	;				
+Ca	CIS ant	CISSUS antarctica - Kangaroo Vine	200mm	10	
#4^	HAR vio	HARDENBERGIA violacea - Purple Coral Pea	200mm	12	
+ Ih	TEC hil	TECOMANTHE hillii - Fraser Island creeper	200mm	4	
GROUNDO	COVERS				
	CAR gla	CARPOBROTUS glaucescens	Tube	112	
}	LOM lon	LOMANDRA longifolia	Tube	17	
+LH	LOM hys	LOMANDRA hystrix	140mm	155	
~~~	LOM ver	LOMANDRA verday	Tube	161	
	SCA aem	SCAEVOLA aemula - Fairy Fan-Flower	140mm	04 317	
} }	IPO pes	IPOMOEA pes-caprae	Tube	82	
				\ \	

### PLANTING SCHEDULE - T3 REPLACEMENT

SYMBOL	CODEGEN	US / SPECIES - COMMON NAMEPOT SIZE	SIZE	QUANTITY
SHRUBS				
+Ac	ALP cae	ALPINIA caerulea - Native Ginger	140mm	18
→Br	BAN rob	BANKSIA robur - Swamp Banksia	200mm /	3
⊣ ^{Bi}	BLE ind	BLECHNUM indicum - Swamp Water Fern	200mm	72
+Sa	SYZ aus	SYZYGIUM australe - Lilly Pilly	200mm	24
+ ^{Ha}	HOV acu	HOVEA acutifolia - Purple Pea Bush	140mm	9
<b>+</b> ^{Fgi}	FIC GI	FICUS 'Green Island'	200mm	30
<b>-t</b> Mt	MEL thy	MELALEUCA thymifolia - Thyme Honey-Myrtle	200mm	8
<b>-</b> Ma	MEL aff	MELASTOMA affine	200mm	13
<b>∔</b> sp	LEP pet	LEPTOSPERMUM petersonii	200mm	3
CLIMBERS				
<b>4</b> Ca	CIS ant	CISSUS antarctica - Kangaroo Vine	200mm	6
<b>4</b> Th	TEC hil	TECOMANTHE hillij. Fraser Island creeper	200mm	7
GROUNDC	OVERS			
	CAR gla	CARPOBROTUS glaucescens	Tube	32
***************************************	BAL pal	BALOSKION pallens	Tube	17
} }	LOM lon	LOMANDRA longifolia	Tube	66
+LH	LOM hys	LOMANDRA hystrix	140mm	29
<b>~~~</b>	LOM ver	LOMANDRA verday	Tube	42
	MYO e	MYOPORUM ellipticum - Coastal Boobialla	140mm	32
	MYO par	MYOPORUM parvifolium - Boobialla	140mm	48
·	SCA aem	SCAEVOLA aemula - Fairy Fan-Flower	140mm	26
1				

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FOR CONSTRUCTION

ISSUE	CODE	ISSUE DESCRIPTION	BY	CHK	DATE
01	PRE	PRELIMINARY	PA	٧S	10/11/2022
02	CON	CONSTRUCTION	PA	٧S	08/02/2023
03	CON	CONSTRUCTION	PA	٧S	14/03/2023
04	CON	CONSTRUCTION	PA	٧S	06/09/2023
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PRE-P	reiiinina	ry   CA - Council Approval   T - T	ender	LCOL	v - Construc
DR/	MINA	G TITLE			

## PLANTING SCHEDULE

DESIGN : JB DOCUMENT : PA PROJECT : 2022027



REVISION 04 DRAWING NUMBER 2022027-003

NOTE: 25 EXISTING TREES TO BE REMOVED 56 NEW TREES TO BE ADDED

04

#### TREE PROTECTION LEGEND



EXISTING TREE TO BE RETAINED. For tree species refer number to Arborist's Report NOTE: No uprooting to existing trees



EXISTING TREE TO BE REMOVED. For tree species refer number to Arborist's Report



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01	PRE	PRELIMINARY	PA	٧S	10/11/2022
02	CON	CONSTRUCTION	PA	٧S	08/02/2023
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04	CON	CONSTRUCTION	PA	٧S	06/09/2023
PRE - F	relimina	ry   CA - Council Approval   T - T	ender	COI	N - Construction
DRA	MIW	G TITLE			

DRAWING TITLE

## EXISTING TREES PLAN: SHEET 1

DESIGN : JB

DOCUMENT : PA

PROJECT : 2022027



#### TREE PROTECTION LEGEND



EXISTING TREE TO BE RETAINED.
For tree species refer number to Arborist's Report NOTE: No uprooting to existing trees



EXISTING TREE TO BE REMOVED. For tree species refer number Arborist's Report



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ISSUE	CODE	ISSUE DESCRIPTION	BY	СНК	DATE		
01	PRE	PRELIMINARY	PA	٧S	10/11/2022		
02	CON	CONSTRUCTION	PA	٧S	08/02/2023		
03	CON	CONSTRUCTION	PA	٧S	14/03/2023		
04	CON	CONSTRUCTION	PA	٧S	06/09/2023		
PRE - F	relimina	ıry   CA - Council Approval   T - 1	Tende	1001	N - Constructio		
DRA	DRAWING TITLE						

DRAWING TITLE

## EXISTING TREES PLAN: SHEET 2

DESIGN : JB
DOCUMENT : PA
PROJECT : 2022027



2 4 6 8 10:0 SCALE 1:200 @ A1 1:400 @ A3 DRAWING NUMBER REVISION 2022027-102 04


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EXISTING TREE TO BE RETAINED. For tree species refer number to Arborist's Report NOTE: No uprooting to



EXISTING TREE TO BE REMOVED. Arborist's Report



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PROJECT
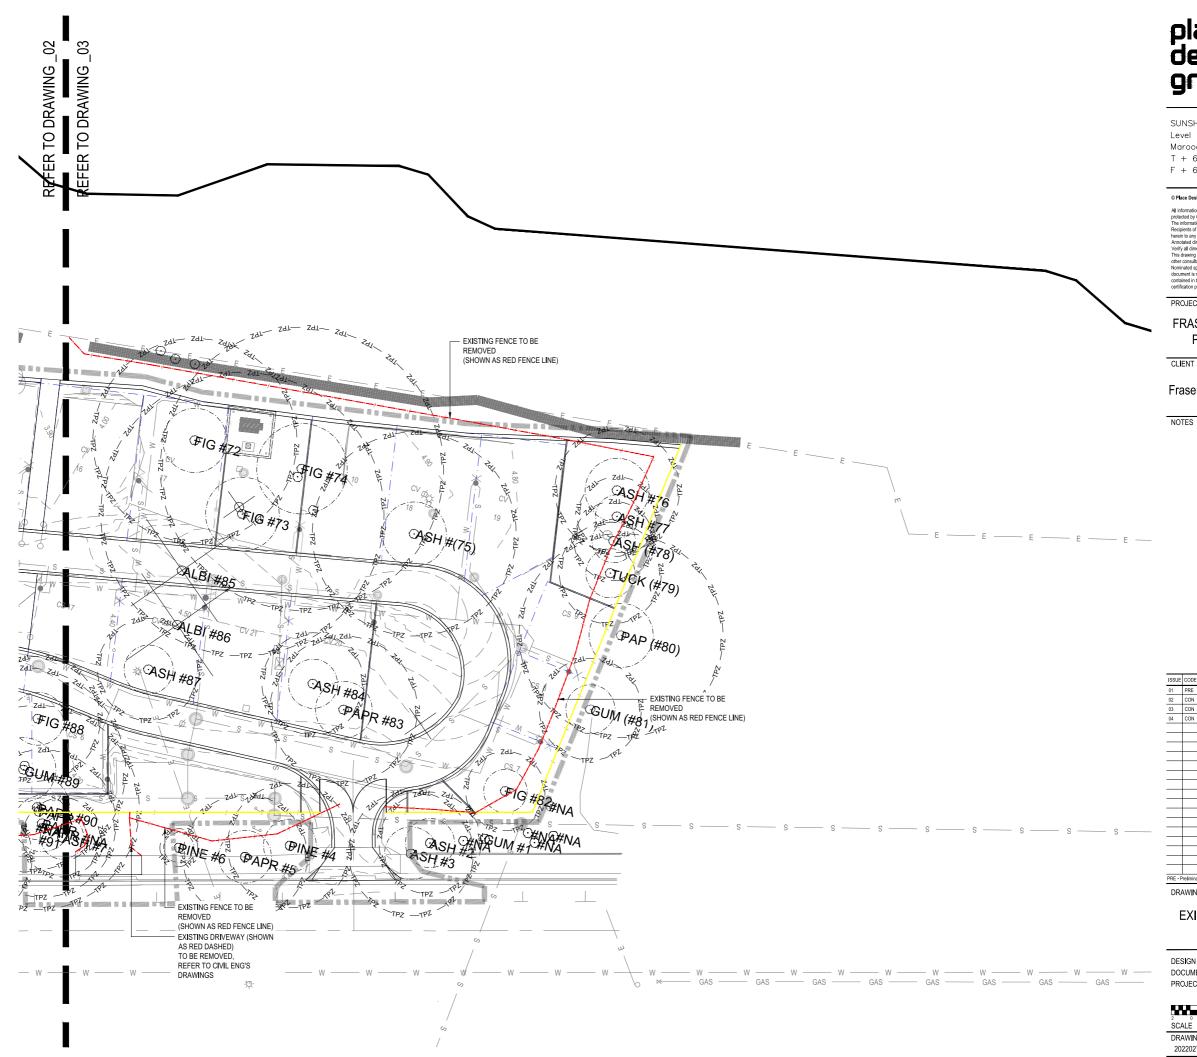
## FRASER COAST CARAVAN PARKS - TORQUAY

CLIENT

## Fraser Coast Regional Council

FOR CONSTRUCTION

ISSUE	CODE	ISSUE DESCRIPTION	BY	CHK	DATE
01	PRE	PRELIMINARY	PA	٧S	10/11/2022
02	CON	CONSTRUCTION	PA	٧S	08/02/2023
03	CON	CONSTRUCTION	PA	٧S	14/03/2023
04	CON	CONSTRUCTION	PA	٧S	06/09/2023
PRE - F	relimina	ry   CA - Council Approval   T -	Tender	1001	N - Construct

## **EXISTING TREES PLAN:** SHEET 3

DESIGN : JB DOCUMENT : PA PROJECT : 2022027



SCALE 1:200 @ A1 1:400 @ A3 DRAWING NUMBER REVISION 2022027-103

### place design FINISHES LEGEND P1 - PAVING TYPE 1 REFER TO FINISHES SCHEDULE DRAWING DRAWING P2 - PAVING TYPE 2 EXISTING FENCE TO BE -(SHOWN AS RED FENCE LINE) ဥ SUNSHINE COAST W1 - WALL TYPE 1 REFER TO FINISHES SCHEDULE REFER FT1 -FENCE TYPE 1 F + 61 7 5499 6711 REFER TO FINISHES SCHEDULE © Place Design Group Pty Ltd A.C.N. 082 370 063 FT2 -FENCE TYPE 2 REFER TO FINISHES SCHEDULE FT3 -FENCE TYPE 3 REFER TO FINISHES SCHEDULE EG1 - GARDEN EDGE TYPE 1 REFER TO FINISHES SCHEDULE EG1 - GARDEN EDGE TYPE 1 REFER TO FINISHES SCHEDULE TPZ -EXISTING BUILDING TO BE DEMOLISHED GB1 - GARDEN BED TYPE 1 - ON GRADE REFER TO FINISHES SCHEDULE 0000000 Zdl Zd BIN ENCLOSURE (7 BINS) REFER TO FINISHES SCHEDULE PROPOSED NEW FENCE -T2 - TURF TYPE 2 REFER TO FINISHES SCHEDULE LOCATION OF FENCE POSTS TO BE DETERMINED ON SITE TO AVOID TREE ROOT T3 - TURF TYPE 3 REFER TO FINISHES SCHEDULE EXTENT OF WORKS CAMPING SITE BDY EXISTING TREE TO REMAIN NEW PROPOSED TREE FOR CONSTRUCTION SERVICES LEGEND T1 ____ w ___ WATER --- ELECTRICAL TELECOMMUNICATIONS ROOT BARRIER (REFER TO EXISTING GARDEN BED TO REMAIN, MAKE GOOD IF DAMAGED PADMOUNT, REFER TO CIVIL TPZ -TPZ -TPZ EXISTING FENCE TO BE PROPOSED NEW FENCE FENCE POST TO AVOID (SHOWN AS RED FENCE LINE) EXISTING PATH TO REMAIN, MAKE GOOD IF DAMAGED EXISTING ACCESS (SHOWN AS RED DASHED LINE) DOCUMENT : PA TO CIVIL ENG'S DETAILS PROJECT : 2022027 REINSTATED TURF AREA REINSTATED EXISTING FOOTPATH, REFER TO CIVIL ENG'S DETAILS SCALE 1:200 @ A1 REINSTATED GARDEN BED DRAWING NUMBER

# group.

Level 1, 24 Duporth Avenue Maroochydore, QLD 4558 T + 61 7 5499 6188

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	CON	CONSTRUCTION	PA	٧S	14/03/2023			
	CON	CONSTRUCTION	PA	٧S	06/09/2023			
- P	- Preliminary   CA - Council Approval   T - Tender   CON - Construction							
RAWING TITLE								

#### SURFACES PLAN: SHEET 1



1:400 @ A3 REVISION 2022027-201

#### place design EFER TO DRAWING_03 REFER TO DRAWING DRAWING ER TO DRAWING group. SUNSHINE COAST Level 1, 24 Duporth Avenue - LINE OF EXISTING RETAINING WALL Maroochydore, QLD 4558 T + 61 7 5499 6188 EXISTING FENCE TO BE F + 61 7 5499 6711 REMOVED (SHOWN AS RED FENCE LINE) © Place Design Group Pty Ltd A.C.N. 082 370 063 All information displayed, transmitted or carried within this drawing is protected by Copyright and Intellectual Property laws. The information contained in this document is confidential. Recipients of this document are prohibited from disclosing the inform. EXISTING AMENITY TO BE RETAINED FOR DEMOLITION DURING STAGE 2 WORKS. LINE OF EXISTING RETAINING WALL T1 FRASER COAST CARAVAN PARKS - TORQUAY TPZ _ GB1 - GARDEN BED TYPE 1 - ON GRADE Fraser Coast Regional Council __TPZ 201+ ZOI_CV 25 EXISTING TREE TO REMAIN BIN ENCLOSURE (12 BINS) FOR CONSTRUCTION BIN ENCLOSURE (23 BINS) TPZ —TPZ (T1) EXISTING FENCE TO BE EXISTING GARDEN BED -TO BE REMOVED EXISTING FENCE TO BE -(SHOWN AS RED FENCE LINE) SURFACES PLAN: EXISTING WASH BAY TO BE REMOVED PROPOSED NEW FENCE -REINSTATED GARDEN BED (SHOWN AS RED FENCE LINE) SHEET 2 LOCATION OF FENCE POSTS REINSTATED EXISTING FOOTPATH PROPOSED NEW FENCE -TO BE DETERMINED ON SITE TO ENTRY WALL WITH SIGNAGE AVOID TREE ROOTS LOCATION OF FENCE POSTS REINSTATED TURF AREA TO BE DETERMINED ON EXISTING PATH TO REMAIN SITE TO AVOID TREE ROOTS / DOCUMENT : PA REINSTATED TURE AREA MAKE GOOD IF DAMAGED PROJECT : 2022027 REINSTATED EXISTING FOOTPATH, REFER TO CIVIL ENGINEER'S DRAWINGS EXISTING GARDEN BED TO REMAIN, MAKE GOOD IF DAMAGED REINSTATED GARDEN BED SCALE 1:200 @ A1 1:400 @ A3 DRAWING NUMBER REVISION 2022027-202

FINISHES LEGEND

P1 - PAVING TYPE 1 REFER TO FINISHES SCHEDULE

REFER TO FINISHES SCHEDULE

REFER TO FINISHES SCHEDULE

REFER TO FINISHES SCHEDULE

FT3 -FENCE TYPE 3 REFER TO FINISHES SCHEDULE

EG1 - GARDEN EDGE TYPE 1 REFER TO FINISHES SCHEDULE

EG1 - GARDEN EDGE TYPE 1 REFER TO FINISHES SCHEDULE

REFER TO FINISHES SCHEDULE

REFER TO FINISHES SCHEDULE

T2 - TURF TYPE 2 REFER TO FINISHES SCHEDULE

CAMPING SITE BDY

NEW PROPOSED TREE

TELECOMMUNICATIONS

ROOT BARRIER (REFER TO

T3 - TURF TYPE 3 REFER TO FINISHES SCHEDULE

EXTENT OF WORKS

SERVICES LEGEND ____ w ___ WATER

---- ELECTRICAL

SEWER

T3

P2 - PAVING TYPE 2

FT1 -FENCE TYPE 1

FT2 -FENCE TYPE 2

UE	CODE	ISSUE DESCRIPTION	BY	CHK	DATE
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	CON	CONSTRUCTION	PA	٧S	06/09/2023
- Preliminary   CA - Council Approval   T - Tender   CON - Construction					
RAWING TITLE					

## FINISHES LEGEND P1 - PAVING TYPE 1 REFER TO FINISHES SCHEDULE REFER TO DRAWING_( P2 - PAVING TYPE 2 W1 - WALL TYPE 1 REFER TO FINISHES SCHEDULE FT1 -FENCE TYPE 1 REFER TO FINISHES SCHEDULE FT2 -FENCE TYPE 2 REFER TO FINISHES SCHEDULE FT3 -FENCE TYPE 3 REFER TO FINISHES SCHEDULE EG1 - GARDEN EDGE TYPE 1 REFER TO FINISHES SCHEDULE PROJECT EG1 - GARDEN EDGE TYPE 1 REFER TO FINISHES SCHEDULE - EXISTING FENCE TO BE (SHOWN AS RED FENCE LINE) CLIENT GB1 - GARDEN BED TYPE 1 - ON GRADE - LINE OF EXISTING RETAINING WALL REFER TO FINISHES SCHEDULE REFER TO FINISHES SCHEDULE NOTES T2 - TURF TYPE 2 REFER TO FINISHES SCHEDULE T3 - TURF TYPE 3 REFER TO FINISHES SCHEDULE EXTENT OF WORKS 04 CAMPING SITE BDY EXISTING TREE TO REMAIN PROPOSED NEW FENCE -NEW PROPOSED TREE LOCATION OF FENCE POSTS 20 201 TO BE DETERMINED ON SITE TO AVOID TREE ROOT ZdI ZdI SERVICES LEGEND — w — WATER EXISTING FENCE TO BE T1 REMOVED ---- ELECTRICAL (SHOWN AS RED FENCE LINE) TELECOMMUNICATIONS ROOT BARRIER (REFER TO EXISTING PATH TO REMAIN -TPZ EXISTING FENCE TO BE _TPZ EXISTING GARDEN BED TO REMAIN, MAKE GOOD IF DAMAGED (SHOWN AS RED FENCE LINE) REINSTATED TURF AREA EXISTING DRIVEWAY (SHOWN REINSTATED EXISTING FOOTPATH TO BE REMOVED REFER TO CIVIL ENG'S REINSTATED GARDEN BED DRAWINGS REINSTATED GARDEN BED REINSTATED TURF AREA REINSTATED EXISTING FOOTPATH REINSTATED EXISTING FOOTPATH REINSTATED GARDEN BED REINSTATED TURF AREA

# place design group.

SUNSHINE COAST Level 1, 24 Duporth Avenue Maroochydore, QLD 4558 T + 61 7 5499 6188 F + 61 7 5499 6711

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PRE - Preliminary   CA - Council Approval   T - Tender   CON - Construction					
DRAWING TITLE					

#### SURFACES PLAN: SHEET 3

DOCUMENT : PA PROJECT : 2022027



SCALE 1:200 @ A1 1:400 @ A3 DRAWING NUMBER REVISION 2022027-203



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FRASER COAST CARAVAN PARKS - TORQUAY

Fraser Coast Regional Council

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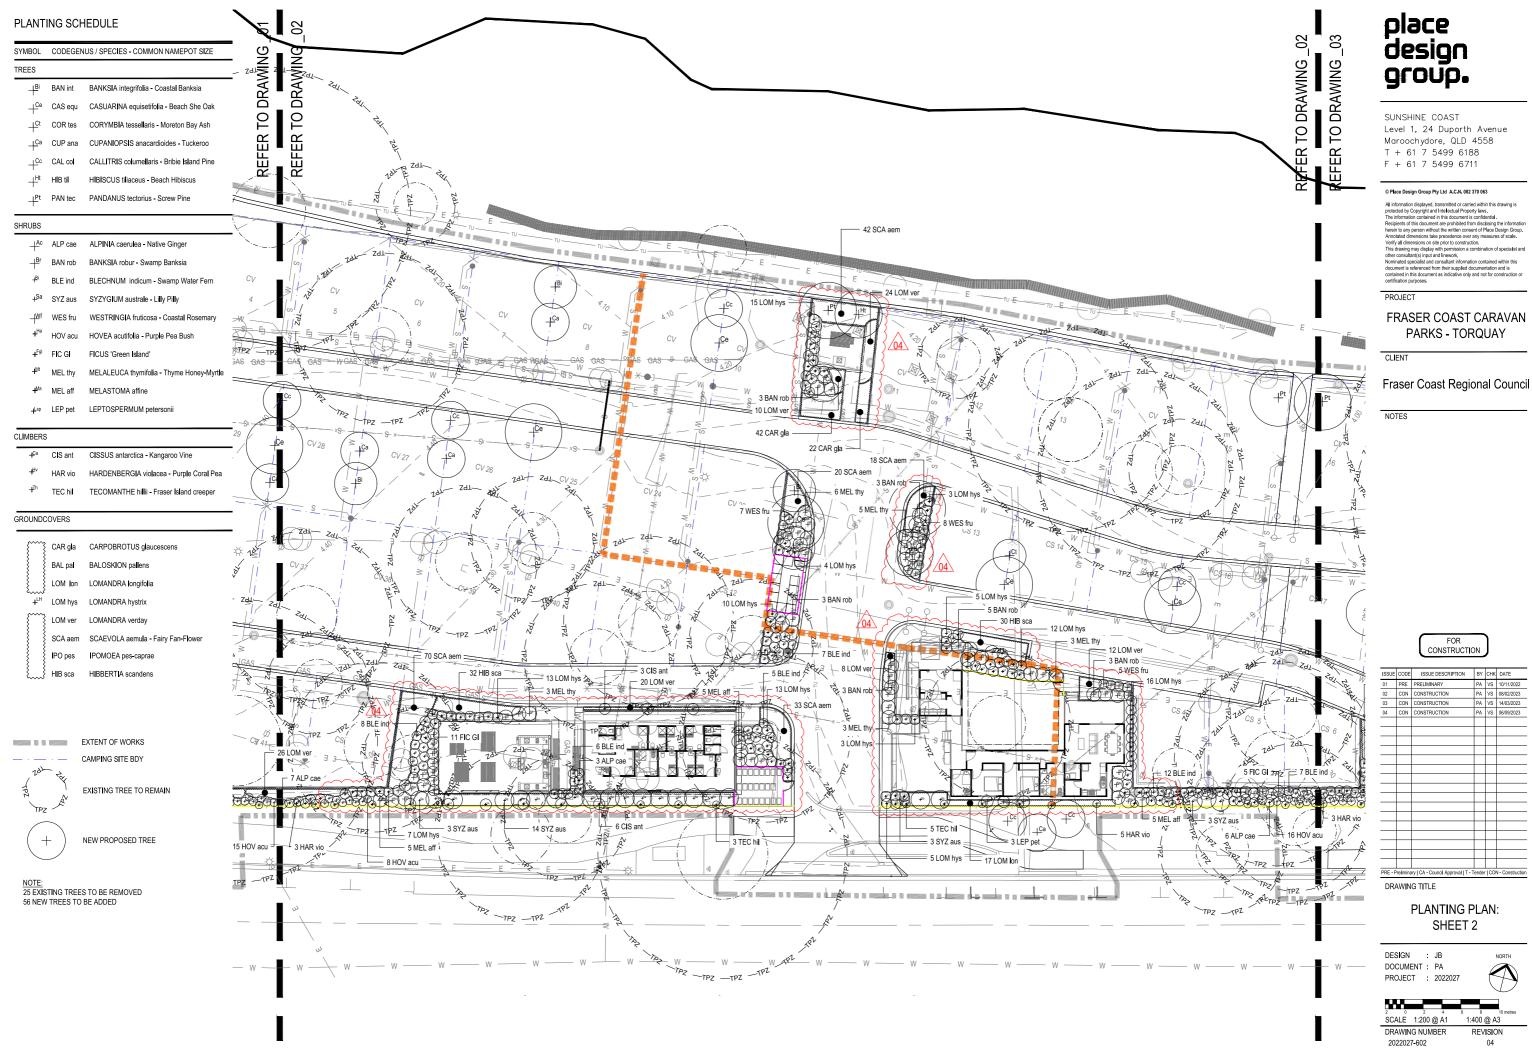
SUE	CODE	ISSUE DESCRIPTION	BY	СНК	DATE
	PRE	PRELIMINARY	PA	VS	10/11/2022
	CON	CONSTRUCTION	PA	٧S	08/02/2023
	CON	CONSTRUCTION	PA	٧S	14/03/2023
	CON	CONSTRUCTION	PA	٧S	06/09/2023
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## PLANTING PLAN: SHEET 1

DOCUMENT : PA PROJECT : 2022027



SCALE 1:200 @ A1 1:400 @ A3 DRAWING NUMBER REVISION



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	PRE	PRELIMINARY	PA	VS	10/11/2022
	CON	CONSTRUCTION	PA	٧S	08/02/2023
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